



Building Permit Application

Howard County Maryland
Department of Inspections, Licenses and Permits
3430 Court House Drive
Permits: 410-313-2455
www.howardcountymd.gov

Date Received: _____

Permit No.: B17000850

Building Address: 1939 Old Mill Road
 City: Washington State: MD Zip Code: 21157
 Suite/Apt. # _____ SDP/WP/BA #: _____
 Census Tract: _____ Subdivision: _____
 Section: _____ Area: _____ Lot: _____
 Tax Map: _____ Parcel: _____ Grid: _____
 Zoning: _____ Map Coordinates: _____ Lot Size: _____

Existing Use: None to be constructed
 Proposed Use: Home Bld. No. 2000
 Estimated Construction Cost: \$ 17,800
 Description of Work: Construction of 2000 sq. ft. home for Howard Rd. maintenance yard. No. 2000. 00424
 Occupant/Tenant Name: _____
 Was tenant space previously occupied? Yes No
 Contact Name: _____
 Address: _____
 City: _____ State: _____ Zip Code: _____
 Phone: _____ Fax: _____
 Email: _____

Commercial Building Characteristics	Residential Building Characteristics
Height: _____	<input type="checkbox"/> SF Dwelling <input type="checkbox"/> SF Townhouse
No. of stories: _____	Depth Width
Gross area, sq. ft./floor: _____	1 st floor: <u>40 x 34</u>
	2 nd floor: _____
Area of construction (sq. ft.): _____	Basement: _____
	<input type="checkbox"/> Finished Basement
Use group: _____	<input type="checkbox"/> Unfinished Basement
	<input type="checkbox"/> Crawl Space
Construction type:	<input type="checkbox"/> Slab on Grade
<input type="checkbox"/> Reinforced Concrete	No. of Bedrooms: _____
<input type="checkbox"/> Structural Steel	Multi-family Dwelling
<input type="checkbox"/> Masonry	No. of efficiency units: _____
<input type="checkbox"/> Wood Frame	No. of 1 BR units: _____
<input type="checkbox"/> State Certified Modular	No. of 2 BR units: _____
	No. of 3 BR units: _____
	Other Structure: _____
	Dimensions: _____
<input checked="" type="checkbox"/> Roadside Tree Project Permit	Footings: _____
<input type="checkbox"/> Yes <input checked="" type="checkbox"/> No	Roof: _____
Roadside Tree Project Permit #	<input type="checkbox"/> State Certified Modular
	<input type="checkbox"/> Manufactured Home

Property Owner's Name: John A. Sargent
 Address: 1939 Old Mill Road
 City: Washington State: MD Zip Code: 21157
 Phone: 301-454-1748 Fax: _____
 Email: john@sargent.com

Applicant's Name & Mailing Address, (If other than stated herein)
 Applicant's Name: _____
 Address: _____
 City: _____ State: _____ Zip Code: _____
 Phone: _____ Fax: _____
 Email: _____

Contractor Company: Shirley P. Brown
 Contact Person: Shirley P. Brown
 Address: 207 Southview Road
 City: Washington State: MD Zip Code: 21157
 License No.: MAK172197
 Phone: 410-945-1828 Fax: 410-945-3011
 Email: shirley@shirleybrown.com

Engineer/Architect Company: _____
 Responsible Design Prof.: _____
 Address: _____
 City: _____ State: _____ Zip Code: _____
 Phone: _____ Fax: _____
 Email: _____

Utilities	
Electric:	<input type="checkbox"/> Yes <input checked="" type="checkbox"/> No
Gas:	<input type="checkbox"/> Yes <input checked="" type="checkbox"/> No
Water Supply	
<input type="checkbox"/> Public	
<input checked="" type="checkbox"/> Private	<u>NA</u>
Sewage Disposal	
<input type="checkbox"/> Public	
<input checked="" type="checkbox"/> Private	<u>NA</u>
Heating System	
<input type="checkbox"/> Electric	<input type="checkbox"/> Oil
<input type="checkbox"/> Natural Gas	<input type="checkbox"/> Propane Gas
<input type="checkbox"/> Other:	<u>NA</u>
Sprinkler System:	
<input type="checkbox"/> Yes	<input checked="" type="checkbox"/> No
RECEIVED	
MAR 03 2017	
Grading Permit Number:	
LICENSES & PERMITS DIVISION	
Building Shell Permit Number:	

THE UNDERSIGNED HEREBY CERTIFIES AND AGREES AS FOLLOWS: (1) THAT HE/SHE IS AUTHORIZED TO MAKE THIS APPLICATION; (2) THAT THE INFORMATION IS CORRECT; (3) THAT HE/SHE WILL COMPLY WITH ALL REGULATIONS OF HOWARD COUNTY WHICH ARE APPLICABLE THERETO; (4) THAT HE/SHE WILL PERFORM NO WORK ON THE ABOVE REFERENCED PROPERTY NOT SPECIFICALLY DESCRIBED IN THIS APPLICATION; (5) THAT HE/SHE GRANTS COUNTY OFFICIALS THE RIGHT TO ENTER ONTO THIS PROPERTY FOR THE PURPOSE OF INSPECTING THE WORK PERMITTED AND POSTING NOTICES.

Applicant's Signature: [Signature]
 Email Address: john@sargent.com
 Title/Company: SELF PROP. OWNER

Print Name: John A. Sargent
 Date: 3-2-2017

Checks Payable to: DIRECTOR OF FINANCE OF HOWARD COUNTY

PLEASE WRITE NEATLY & LEGIBLY


-FOR OFFICE USE ONLY-

AGENCY	DATE	SIGNATURE OF APPROVAL
State Highways		
Building Officials		
PSZA (Zoning)		
PSZA (Engineering)		
Health	<u>3/27/17</u>	<u>H. Oswald</u>

DPZ SETBACK INFORMATION	
Front:	
Rear:	
Side:	
Side St.:	
All minimum setbacks met?	<input type="checkbox"/> Yes <input type="checkbox"/> No
Is Entrance Permit Required?	<input type="checkbox"/> Yes <input type="checkbox"/> No
Historic District?	<input type="checkbox"/> Yes <input type="checkbox"/> No
Lot Coverage for New Town Zone:	
SDP/Red-line approval date:	

Filing Fee	\$
Permit Fee	\$
Tech Fee	\$
Excise Tax	\$
PSFS	\$
Guaranty Fund	\$
Add'l per Fee	\$
Total Fees	\$
Sub- Total Paid	\$
Balance Due	\$
Check	# <u>1088</u>

Distribution of Copies: White: Building Officials Green: PSZA,Zoning Yellow: PSZA,Engineering Pink: Health Gold: SHA

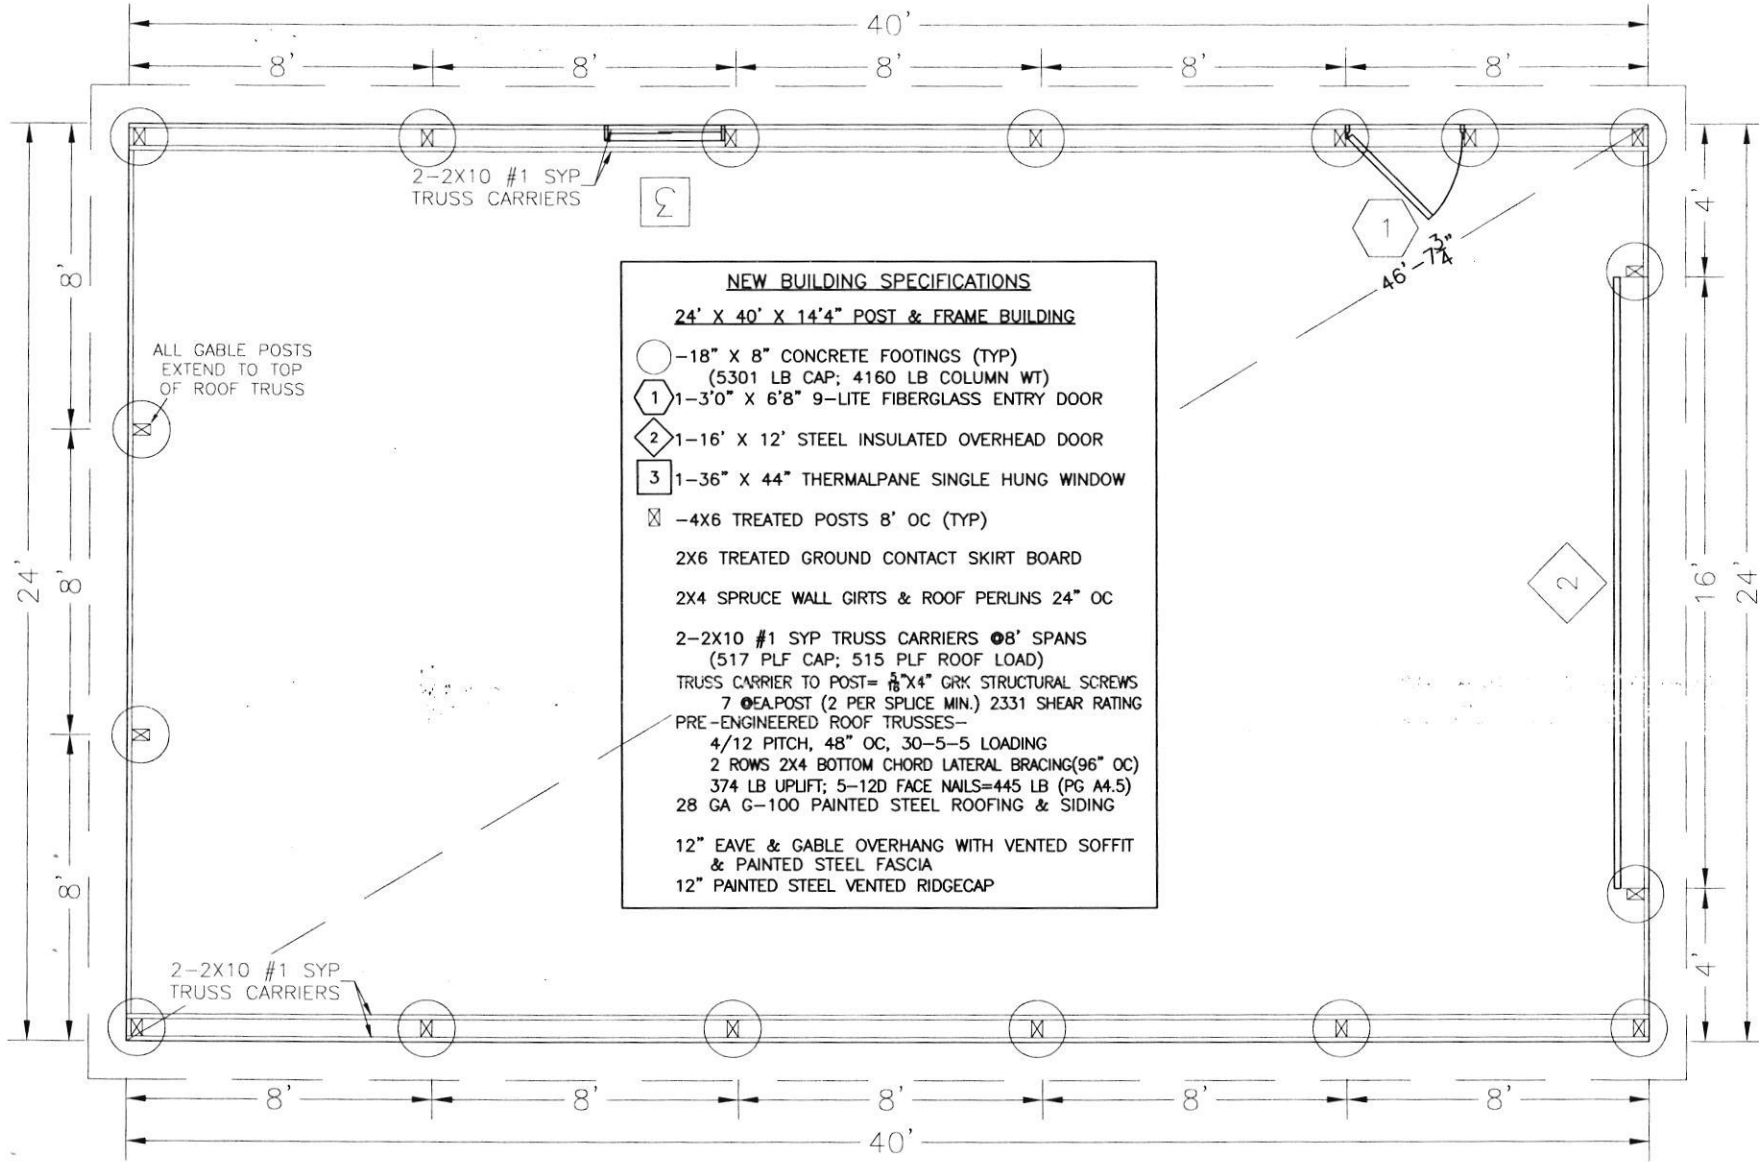

NEW BUILDING SPECIFICATIONS
24' X 40' X 14'4" POST & FRAME BUILDING

- -18" X 8" CONCRETE FOOTINGS (TYP)
 (5301 LB CAP; 4160 LB COLUMN WT)
- ① 1-3'0" X 6'8" 9-LITE FIBERGLASS ENTRY DOOR
- ② 1-16' X 12' STEEL INSULATED OVERHEAD DOOR
- ③ 1-36" X 44" THERMALPANE SINGLE HUNG WINDOW
- ⊠ -4X6 TREATED POSTS 8' OC (TYP)
- 2X6 TREATED GROUND CONTACT SKIRT BOARD
- 2X4 SPRUCE WALL GIRTS & ROOF PERLINS 24" OC
- 2-2X10 #1 SYP TRUSS CARRIERS @8' SPANS
 (517 PLF CAP; 515 PLF ROOF LOAD)
- TRUSS CARRIER TO POST= 5/8"X4" GRK STRUCTURAL SCREWS
 7 @EA.POST (2 PER SPLICE MIN.) 2331 SHEAR RATING
- PRE-ENGINEERED ROOF TRUSSES-
 4/12 PITCH, 48" OC, 30-5-5 LOADING
 2 ROWS 2X4 BOTTOM CHORD LATERAL BRACING(96" OC)
 374 LB UPLIFT; 5-12D FACE NAILS=445 LB (PG A4.5)
 28 GA G-100 PAINTED STEEL ROOFING & SIDING
- 12" EAVE & GABLE OVERHANG WITH VENTED SOFFIT
 & PAINTED STEEL FASCIA
- 12" PAINTED STEEL VENTED RIDGECAP


OWNER
JOHN SARGEANT
 1939 OLD ANNAPOLIS RD.
 WOODBINE MD 21797

ALL INFORMATION SHOWN ON THIS DRAWING IS THE PROPERTY OF SHIRK POLE BUILDINGS LLC. THIS DRAWING MAY NOT BE REPRODUCED WITHOUT PERMISSION. BUILDER AND OWNER ARE RESPONSIBLE TO VERIFY ALL DIMENSIONS BEFORE CONSTRUCTION.


DRAWN BY: ALS
 REVIEW:
 REVISIONS:

DATE: 2/27/17
 SITE:
 FLOOR PLAN


FLOOR PLAN
 SCALE: 1/4" = 1'0"

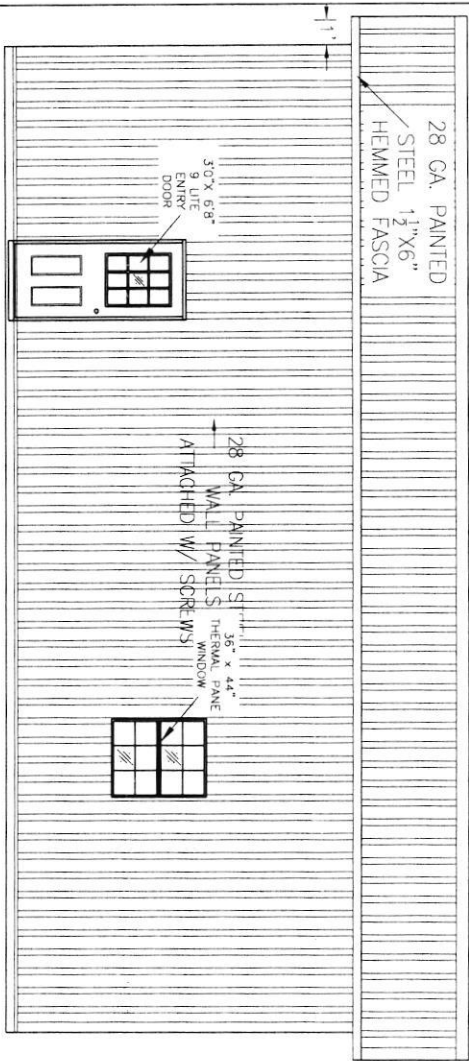


BACK SIDEWALL
SCALE: 3/16" = 1'0"

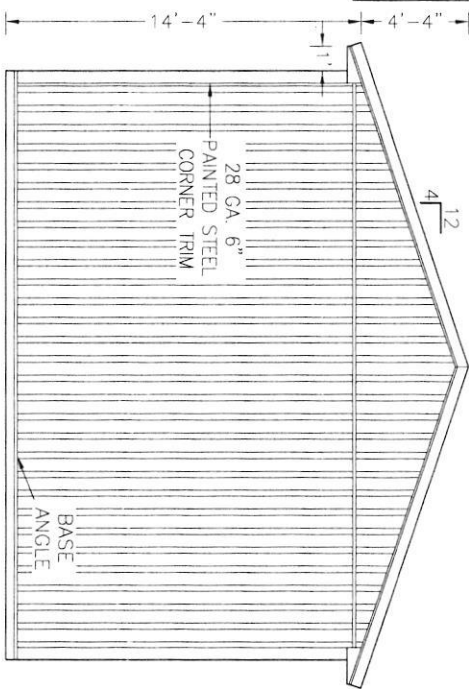

LEFT ENDWALL
SCALE: 3/16" = 1'0"

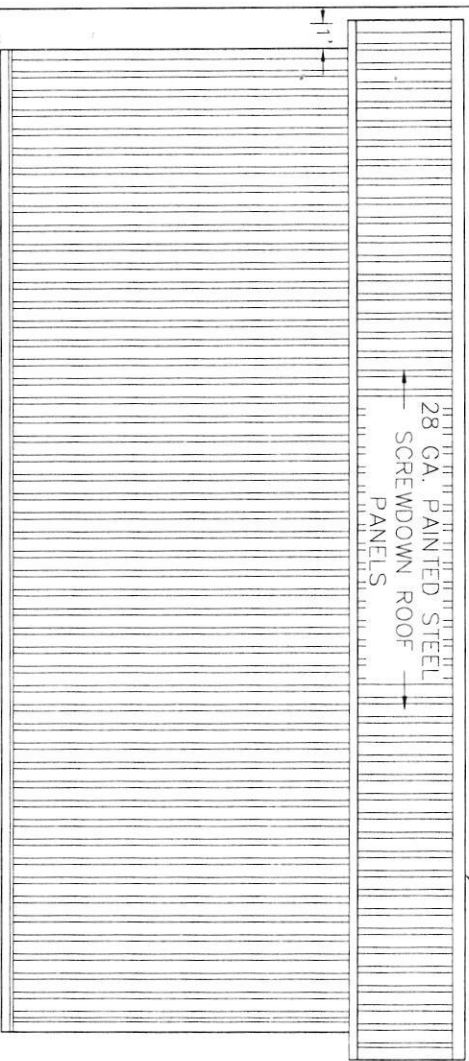

FRONT SIDEWALL
SCALE: 3/16" = 1'0"

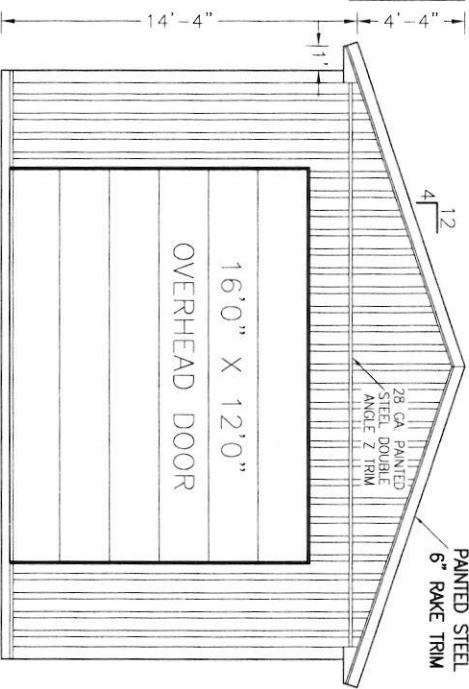

RIGHT ENDWALL
SCALE: 3/16" = 1'0"

28 GA. PAINTED STEEL
12" RIDGECAP (VENTED)

28 GA. PAINTED STEEL
6" RAKE TRIM

16'0" X 12'0"
OVERHEAD DOOR

OWNER
JOHN SARGEANT
1939 OLD ANNAPOLIS RD.
WOODBINE MD 21797

BUILDER
POLE BUILDINGS
SHIRK LLC
807 READING ROAD, EAST EARL, PA 17519
717-445-6888, FAX 717-445-3001

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DRAWN BY: ALS
REVIEW:
REVISIONS:
DATE: 2/27/17
SITE:
ELEVATIONS:
A.2

BUILDING DESIGN NOTES AND DETAILS

- A4.1 GRADING & EXCAVATION
FINISHED GRADE SHALL BE BELOW FLOOR LEVEL WITH ADEQUATE FALL TO CARRY SURFACE WATER AWAY FROM BUILDING. FOOTINGS SHALL BE CIRCULAR (UNLESS NOTED OTHERWISE) AUGURED TO THE DEPTH AND DIAMETER SPECIFIED, WITH ALL LOOSE FILL REMOVED BEFORE CONCRETE FOOTING MATERIAL IS PLACED.
- A4.2 FOOTINGS
STANDARD DEPTH FOR FOOTING EXCAVATION IS 44" FROM FINISH FLOOR HEIGHT. FOOTINGS SHALL BE A MINIMUM OF 36" DEPTH FOR FROST PROTECTION OR, LOCAL BUILDING CODE DEPTH REQUIREMENTS FOR FROST PROTECTION WILL BE FOLLOWED. DRY MIX CONCRETE HYDRATED IN-SITU WILL BE USED UNLESS OTHERWISE SPECIFIED.
- A4.3 FRAMING
LUMBER FOR SIDEWALL GIRTS AND PERLINS SHALL BE #2 SPRUCE OR COMPARABLE. LUMBER FOR SKIRTBARD, POSTS AND BEAMS SHALL BE #2 OR BETTER SOUTHERN YELLOW PINE. TIMBERVALUES FOR 3 PLY 2X6 GLU-LAM: FB=2150, FG=2050. LUMBER FOR TRUSS CARRIERS SHALL BE #1 OR BETTER SOUTHERN YELLOW PINE. ALL GROUND CONTACT LUMBER SHALL BE TREATED TO AWPA U1-09 (COMMODITY SPECIFICATION A, USE CATEGORY 4B AND SECTION 5.2) AND AS(A)SABE)P559. 60 CCA MINIMUM AND SHALL BEAR AN ACCREDITED LABEL USING #1 OR BETTER SYR.
- A4.4 ROOF TRUSSES
ROOF TRUSSES SHALL BE PRE-ENGINEERED, GROUND SNOW LOAD, DRIFT LOAD, COLLATERAL LOAD, AND WIND LOAD ARE TO BE IN ACCORDANCE WITH BUILDING CODE. TRUSS ERIGION AND BRACING SHALL BE PROVIDED ACCORDING TO MANUFACTURERS SPECIFICATIONS. BOTTOM CHORD OF TRUSS SHALL HAVE PERMANENT LATERAL BRACING OF 120" OC. OR AS REQUIRED PER ROOF TRUSS DESIGN. THE DESIGN PROFESSIONAL OF RECORD HAS REVIEWED THE PRE-ENGINEERED ROOF TRUSS DRAWINGS AS PER R502.11.1 & IBC 107.3.4.1 AND THEY COMPLY WITH THE STRUCTURAL DESIGN REQUIREMENTS.
- A4.5 ROOF TRUSSES UPLIFT AND LATERAL CONNECTIONS
PRIMARY ROOF TRUSSES SHALL BE CONNECTED TO THE SIDE OF THE STRUCTURAL POSTS AND INTERMEDIATE ROOF TRUSSES SHALL BE CONNECTED TO THE STRUCTURAL HEADER WITH UPLIFT BLOCKS WITH A SUFFICIENT NUMBER OF FACE NAILS TO OFFSET THE WIND UPLIFT FACTOR AND LATERAL LOADS NOTED ON THE ROOF TRUSS DRAWING IN ACCORDANCE WITH IBC SECTION 2304.9.1, 2308.10.1, AND 2308.10.6
- A4.6 FASTENERS AND FRAMING CONNECTIONS
EPA84 DIAPHRAM DESIGN& ACTIONS FOR METALCLAD BUILDINGS, 2009 IBC 2308.9.3 WIND BRACING REQUIREMENTS, IBC 2009 CONSTRAINED/ UNCONSTRAINED POST REQUIREMENTS& POST TO FOOTING CONNECTION. ALL FRAMING CONNECTIONS SHALL BE OF A SIZE AND DESIGN TO MEET DESIGN LOADS SPECIFIED. NAILS USED IN 60 ACO/COA TREATED WOOD SHALL BE 12D HOT DIPPED GALVANIZED: ASTM A 153 PLATED 1.2 MIL SCREWS, AND A 65 CLASS C 185 HARDWARE. THE MINIMUM AMOUNT OF 12D NAILS IN 2X4 ROOF PERLINS IS 2. THE MINIMUM AMOUNT OF 12D NAILS IN 2X4 WALL GIRTS IS 3. THE MINIMUM # OF 12D NAILS IN 1 1/2" STRUCTURAL TIMBER IS 1 PER 1/2" BOARD WIDTH. TRUSS CARRIER CONNECTION TO POST: 8"x4" GRS RSS STRUCTURAL SCREWS. SCREW VALUES: SHEAR STRENGTH=1328 LB, TENSILE STRENGTH=139,000 PSI, PULLOUT=2644 LBS, HEAD PULL THROUGH=825 LBS, MIN. BENDING ANGLE=35°
- A4.7 METAL SIDING AND ROOFING
METAL SIDING AND ROOFING SHALL BE INSTALLED WITH #9 WOODGRIP, 1/2" HEX HEAD, METAL AND RUBBER WASHERED GALVANIZED COLOR MATCHING SCREWS. FASTENERS SHALL COMPLY WITH THE ROOFING & SIDING MFG'S REQUIREMENTS. METAL SIDING AND ROOFING SHALL BE WARRANTED #1 GRADE 80,000 PSI MIN. TENSILE STRENGTH CORRUGATED 29 GAUGE PAINTED ABM STEEL PANELS GALVANIZED TO A MINIMUM OF G-100. METAL SIDING AND ROOFING SHALL BE TRIMMED WITH CORRECT FLASHINGS AT EXPOSED EDGES, ROOF ENDS, CORNERS, DOORS, WINDOWS AND RIDGES, EXCEPT; BOTTOM EDGE OF STANDARD ROOFING MATERIALS.

- A4.8 CONCRETE FLOOR (OPTIONAL)
FIBER REINFORCED 4000 PSI CONCRETE SLAB ON GRADE OVER COMPACTED BASE. SLAB WILL BE POURED AGAINST SKIRTBARD WITH NO TURN DOWN.
- A4.9 STRUCTURAL DESIGN PARAMETERS
BUILDING USE= STORAGE
USE GROUP=U
EXPOSURE CATEGORY= C
HEIGHT & AREA LIMITATIONS=5B UNPROTECTED
OCCUPANCY LOAD=AS PER DESIGN
TOTAL NUMBER OF FLOORS= 1
TOTAL FLOOR AREA (SQ FT)=960
BUILDING VOLUME (CU FT)=15,680
STRUCTURE IS DESIGNED FOR A MAXIMUM WIND LOAD OF 90 MPH (3 SECOND GUST), AND 70 MPH (10 SECOND GUST) UNLESS NOTED OTHERWISE.
SOIL BEARING CALCULATIONS ARE BASED ON SOIL BASE CONDITION: 3000 PSF @48" BELOW GRADE UNLESS NOTED OTHERWISE.
30 PSF(LIVE) MIN.SNOW, 5 PSF TOP CHORD & 5 PSF BOTTOM CHORD LOADS.

- A4.10 APPLICABLE BUILDING CODES
THESE PLANS ARE DESIGNED IN ACCORDANCE WITH THE FOLLOWING BUILDING CODES:
2015 IBC CODE -MARYLAND
- A4.11 DESIGN CRITERIA:
DESIGN REFERENCES=NFA GUIDELINES FOR POST & FRAME CONSTRUCTION& NDS 2005 AMERICAN FOREST & PAPER ASSOCIATION (WF&M& NDS 2005 FOR WOOD CONSTRUCTION) SOUTHERN PINE COUNCIL (JOISTS & RAFTERS/ HEADERS & BEAMS) THE AMERICAN INSTITUTE OF TIMBER CONSTRUCTION (AITC 117-93 AND 2/98 ADDENDUM) SOUTHERN BUILDING CODE CONGRESS (SSSTD10) MINIMUM DESIGN LOADS FOR BUILDINGS AND OTHER STRUCTURES (ASCE-7-10) GEORGIA PACIFIC ENGINEERED LUMBER (EDITION VII)

- A4.12 WARRANTY NOTES
ANY DESIGN MODIFICATION OR ANY STRUCTURAL MODIFICATION BEFORE, DURING, OR AFTER CONSTRUCTION TO BUILDING BY ANY PERSON(S) OR COMPANY OTHER THAN WORK PERFORMED OR APPROVED BY SHIRK POLE BUILDINGS, LLC WILL VOID ANY AND ALL WARRANTIES PROVIDED BY MANUFACTURERS AND/OR SHIRK POLE BUILDINGS, LLC. SUCH DESIGN MODIFICATIONS AND/OR STRUCTURAL MODIFICATIONS INCLUDE:
DRILLING, REMOVING, CUTTING, SAWING, SPLINTERING OR DAMAGING ANY STRUCTURAL MEMBERS INCLUDING FOOTINGS, POSTS, GIRTS, BEAMS, TRUSSES, PERLINS, PANELS, WINDOWS, DOORS, NAILS, SCREWS, AND BOLTS.
SUCH DESIGN MODIFICATIONS AND/OR STRUCTURAL MODIFICATIONS ALSO INCLUDE:
ADDING ADDITIONS, SNOW DRIFT LOAD FROM ADDITIONS, LEAN-TOS, ATTIC STORAGE, CHAIN HOISTS, OPENINGS, SKYLIGHTS, ROOF VENIS, AND LOUVERS.
SHIRK POLE BUILDINGS, LLC WILL NOT BE LIABLE FOR ANY FAILURES RESULTING FROM THOSE MODIFICATIONS LISTED ABOVE, OR FROM ANY OTHER MODIFICATIONS NOT APPROVED BY A CERTIFIED ENGINEER.

- A4.13 CONTRACTOR LICENSING
MHC 92197 EXPIRES 04-03-2018



OWNER
JOHN SARGEANT
1939 OLD ANNAPOLIS RD.
WOODBINE MD 21797

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DRAWN BY: ALS
REVIEW:
REVISIONS:
DATE: 2/27/17
SITE:
DETAILS

A.4

GRID NORTH

NON-BUILDABLE PRES. PARCEL 'D'
THE PRESERVES AT CLARKSVILLE
PLAT NO. 19215-16

PRIVATE
DRAINAGE &
UTILITY
EASEMENT

S 00°23'28" W

R&C SET

R/C FND CLSI

135.23'

30' BRL

Notes:

- 1.) R&C=Rebar with yellow cap stamped "Prop. Cor.-BEI-351"
- 2.) Distances are plat distances, Grid North is the Maryland State plane projection of the North American Datum of 1983 as on Plat#19215.

LOT 30
THE PRESERVES AT CLARKSVILLE
PLAT NO. 19215


197'

LOT 28
THE PRESERVES AT CLARKSVILLE
PLAT NO. 19215

SURVEYOR'S CERTIFICATE

I HEREBY CERTIFY THAT THESE DOCUMENTS, WERE PREPARED BY ME OR UNDER MY RESPONSIBLE CHARGE, ALL IN COMPLIANCE WITH REGULATION 09.13.03.12 OF THE CODE OF MARYLAND REGULATIONS, AND THAT I AM A DULY LICENSED PROFESSIONAL LAND SURVEYOR UNDER THE LAWS OF THE STATE OF MARYLAND, LICENSE NO. 21320, EXPIRATION DATE 12/31/2017.


Donald A. Mason
DONALD A. MASON
PROFESSIONAL LAND SURVEYOR
MARYLAND REG. No. 21320
FEMA FIRM No. 24027C0130D
ZONE: X
DATED: 11/06/2013

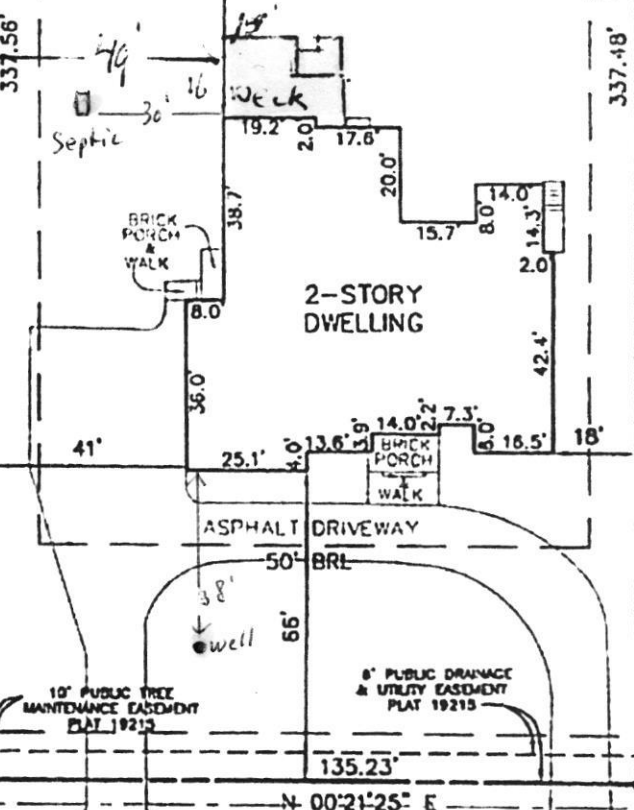

HEATHER GLEN WAY
PUBLIC ACCESS STREET - 50' R/W


Approved Septic System Plan
Howard County Health Department
Dana Buncud 1-11-18
Signature Date
B/7004386

BOUNDARY DRAWING
THE PRESERVE AT CLARKSVILLE
LOTS 1-32
PLAT No. 19215
LOT No. 29
6223 HEATHER GLEN WAY
FIFTH ELECTION DISTRICT
HOWARD COUNTY, MARYLAND
SCALE: 1" = 40' DATE: 03/23/2015

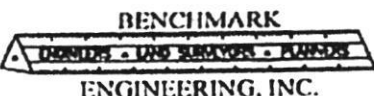

8480 BALTIMORE NATIONAL PIKE • SUITE 315
ELLCOTT CITY, MARYLAND 21043
phone: 410-465-6105 • fax: 410-465-6644
www.bei-cvllengineering.com

FIELD OBS. BY DH&AS
COMP. BY EWF
DRAWN BY EWF

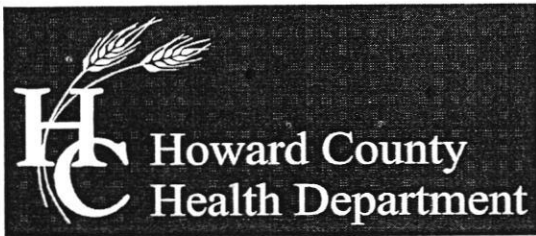

Bureau of Environmental Health

8930 Stanford Boulevard, Columbia, MD 21045

Main: 410-313-2640 | Fax: 410-313-2648

TDD 410-313-2323 | Toll Free 1-866-313-6300

www.hchealth.org

Facebook: www.facebook.com/hocohealth

Twitter: HowardCoHealthDep

Maura J. Rossman, M.D., Health Officer

March 27, 2017

John Sargeant
1939 Old Annapolis Road
Woodbine, MD 21797

RE: Waiver Approval
1939 Old Annapolis Road
Woodbine, MD 21797

Dear Mr. Sargeant,

This letter is being issued in response to your waiver request received on March 15, 2017. This agency has **approved** the waiver to the required Percolation Certification Plan. The approval is based on the fact that the proposed pole barn does not have any plumbing and has a minimal effect on the area available for future on-site sewage disposal system repairs because it is located a substantial distance from the existing on-site sewage disposal system/existing perc test locations. Any deviations from the proposed work indicated on the building permit site plan will be subject to further review by this Department.

Any questions regarding this decision may be directed to the Well and Septic Program of the Howard County Health Department.

Respectfully,

A handwritten signature in cursive script that reads 'Michael J. Davis'.

Michael J. Davis

Assistant Director

Bureau of Environmental Health

March 15, 2017

Bureau of Environmental Health
8930 Stanford Blvd.
Columbia, Md. 21045
Attn: Mr. Hank Oswald, L.E.H.S.
Well and Septic Program

3/27/17
Approved:
Richard J. Lawin

Re: Waiver to the percolation certificate plan
Permit application: B17000850

To: Deputy Director Mike Davis;

Dear Mr. Davis;

In follow up to a letter I received from Mr. Oswald, I am requesting a waiver of the percolation certification plan. I am confident the proposed pole barn location clearly meets the well and septic set back requirements. Also, the proposed use does NOT include any plumbing, hence there will not be any adverse influence upon the current well or septic. The building will solely be used to house a motor home, and a pick up truck.

My original site plan did include the clean out and drain field reference for the primary field. A 2nd percolation was done in 1986, and I am including an amended illustration of the proximity of that additional 10,000 s.f. field to the primary drain field location.

Please contact me at your first convenience if any additional information is required. Thank you for your consideration of this additional information.

Regards,


John Sargeant

John Sargeant, owner
1939 Old Annapolis Rd.
Woodbine, Md. 21797

cc: AShirk@shirkpolebuildings.com

Tom Smeant
1159 7th Guilford Rd
Worcester, MA 01279

ORIENTATION, Prop. Lines
Taken from 1987
Wall Check Survey
Copy Attached
L2008.1228 File 086

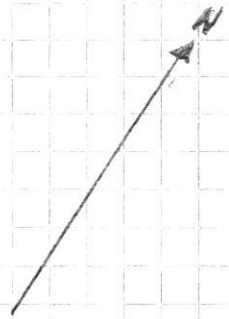

Septic Clean out
scale: 1/4" = 10'
Field

A hatched area representing a field, with an arrow pointing to it from the word "Field".

3/27/17 Site plan approved
as shown for B17000850
(pole barn) - 4.0.

FRONT PROPERTY LINE