




LINE TYPE KEY:  
 NEW WALL   
 ABOVE LINE   
 FDN. WALL 



7612 Browns Bridge Road  
 Highland, MD 20777  
 301-776-2666  
 info@TransformingArchitecture.com  
 www.TransformingArchitecture.com



STAMP

I CERTIFY THAT THESE DOCUMENTS WERE PREPARED OR APPROVED BY ME, AND THAT I AM A DULY LICENSED ARCHITECT UNDER THE LAWS OF THE STATE OF MARYLAND, LICENSE NUMBER 13662, EXPIRATION 10-22-2021.

NOTE: THESE DRAWINGS ARE THE PROPERTY OF TRANSFORMING ARCHITECTURE AND, AS SUCH, MAY NOT BE RE-USED OR REPRODUCED, EITHER WHOLLY OR IN PART, WITHOUT PRIOR WRITTEN CONSENT OF TRANSFORMING ARCHITECTURE.

PROJECT PHASE  
**PERMIT**


PROJECT TITLE  
**THE WIZZARD RESIDENCE**  
 1608 Florence Road  
 MT AIRY, MD 21771

REVISIONS		
SYMBOL	DATE	ISSUED FOR
△	09/14/2021	BUILDING PLAN REVIEW

PROJECT NUMBER 21-594  
 DATE 07/16/2021  
 SCALE AS NOTED


DRAWING TITLE  
**FRAMING AND ROOF PLANS**

SHEET NUMBER  
**A-105**

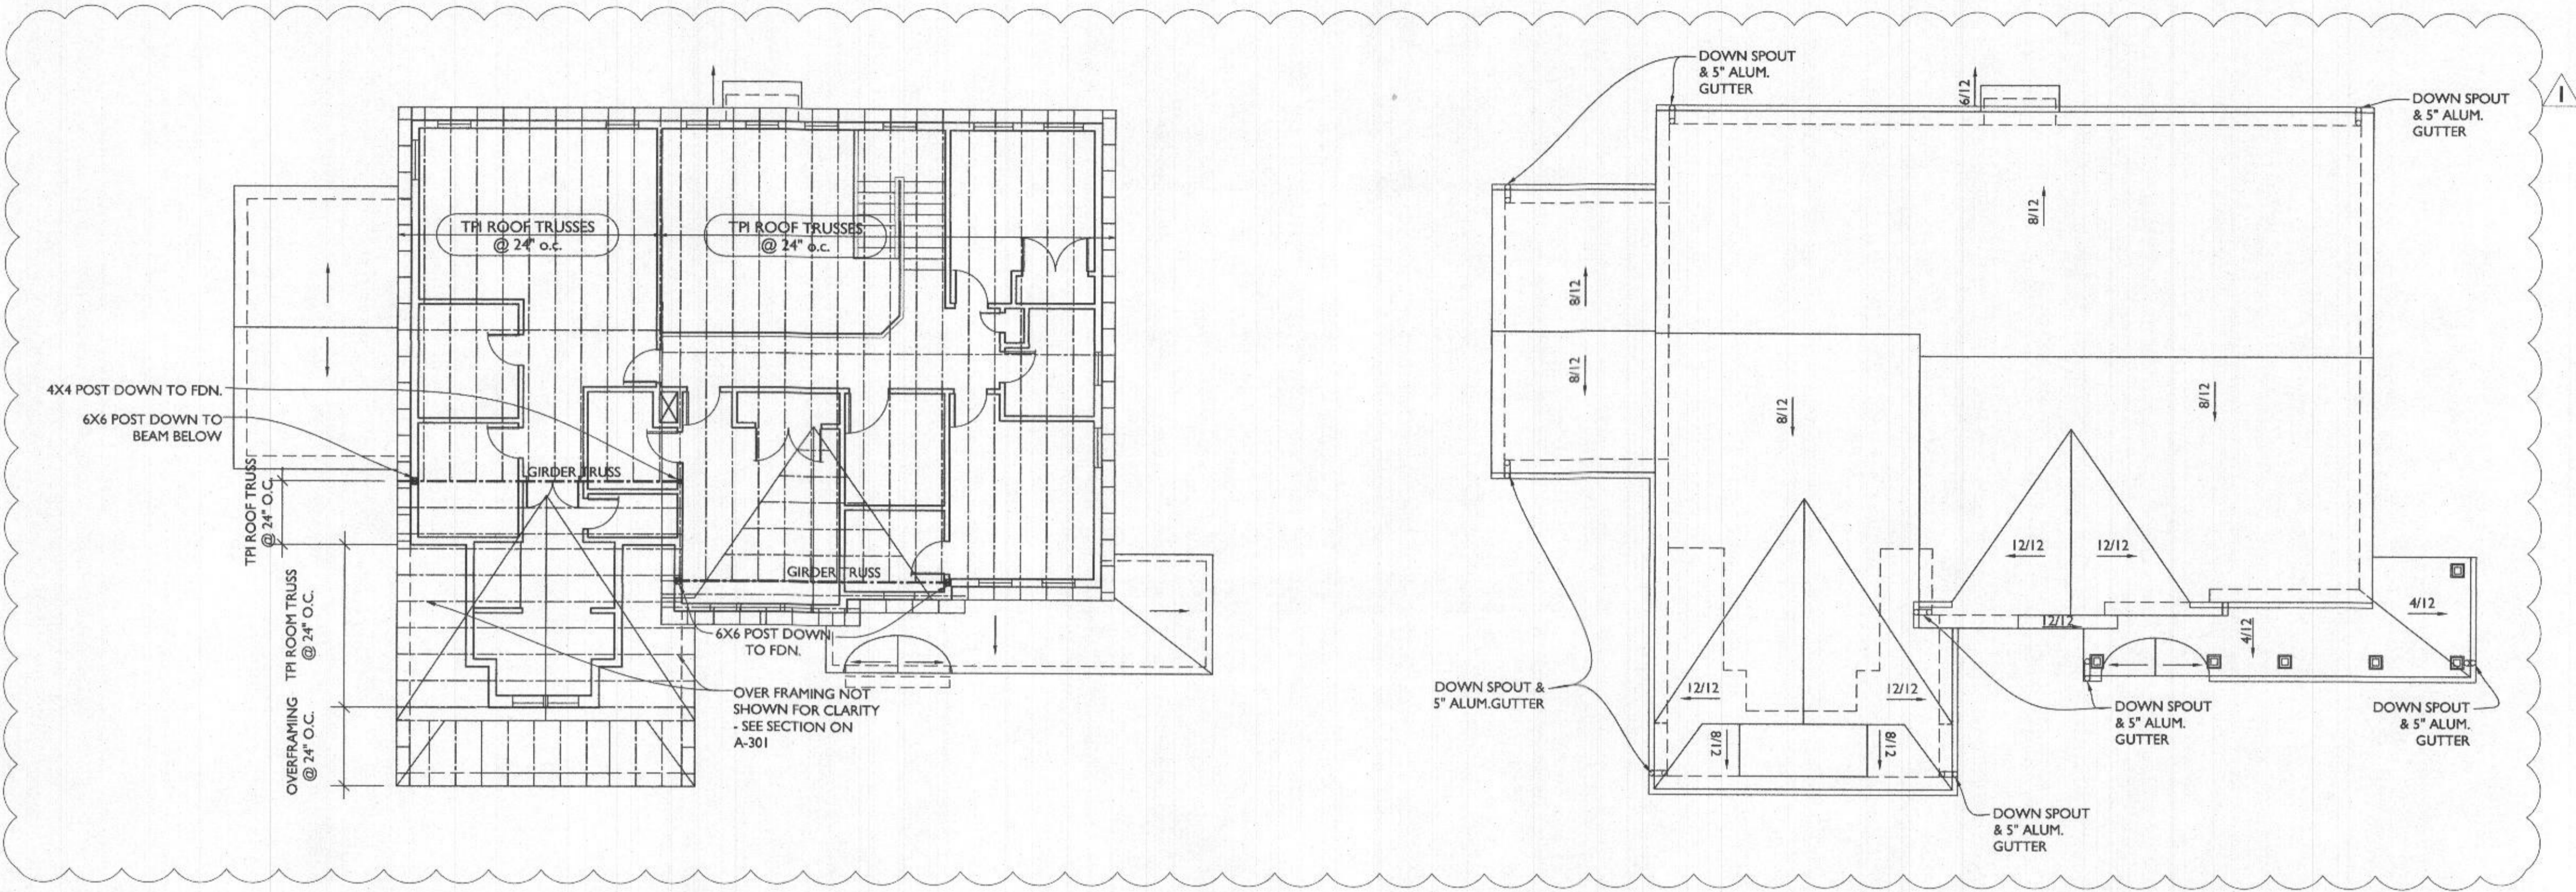


1 ROOF FRAMING PLAN  
 A105 SCALE: 1/8"=1'-0"

2 ROOF PLAN  
 A105 SCALE: 1/8"=1'-0"

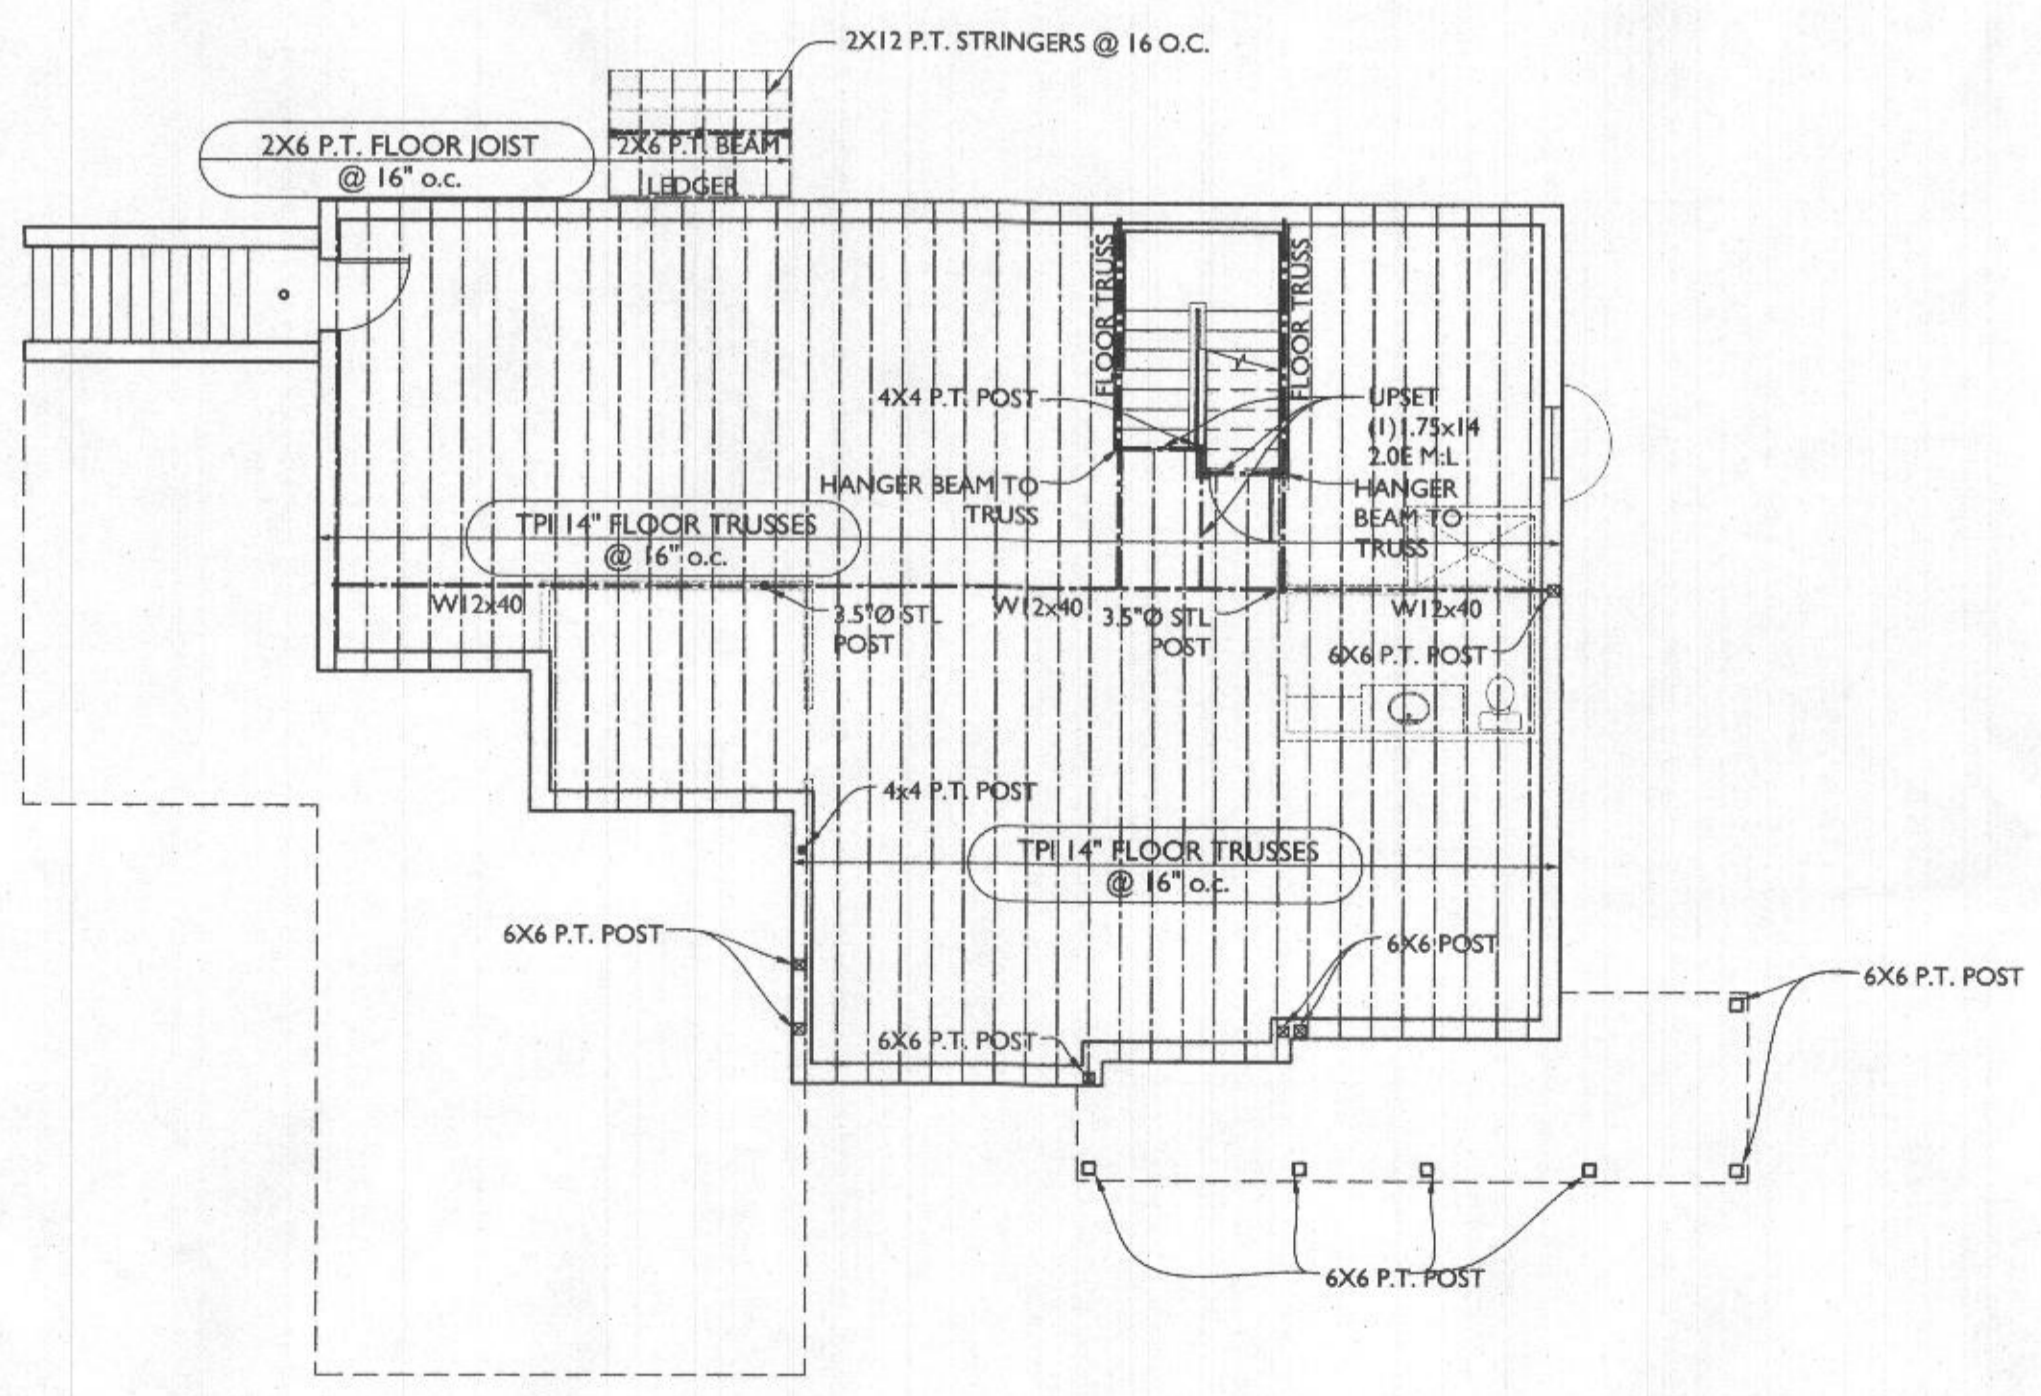

3 FIRST FLOOR FRAMING PLAN  
 A105 SCALE: 1/8"=1'-0"

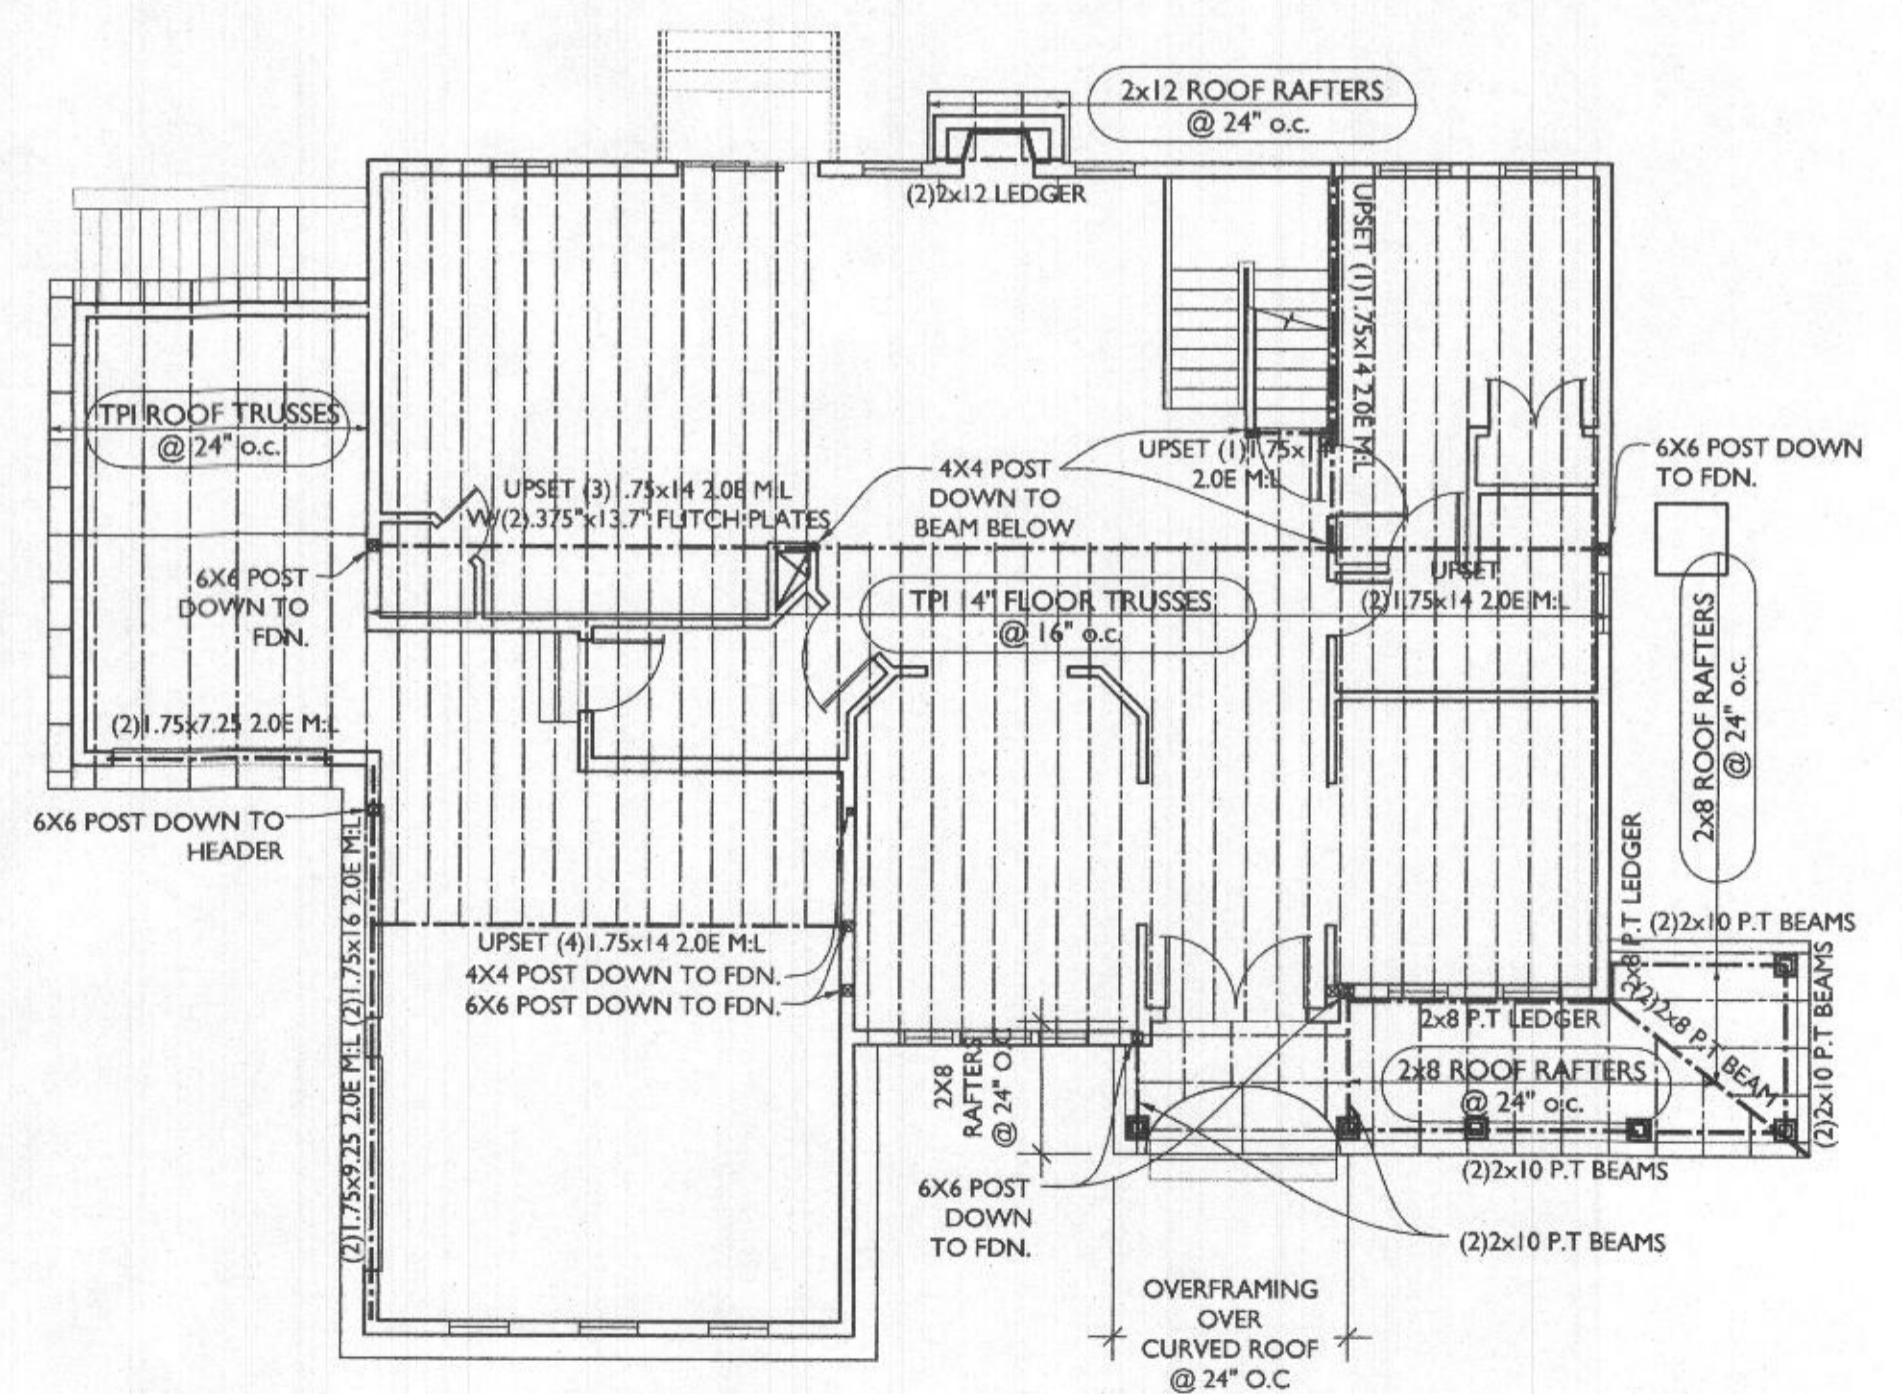

4 SECOND FLOOR FRAMING PLAN  
 A105 SCALE: 1/8"=1'-0"

TABLE R602.3(1)  
FASTENER SCHEDULE FOR STRUCTURAL MEMBERS

ITEM	DESCRIPTION OF BUILDING ELEMENTS	NUMBER AND TYPE OF FASTENER (*a,*b,*c)	SPACING OF FASTENERS
<b>ROOF</b>			
1	BLOCKING BETWEEN JOISTS OR RAFTERS TO TOP PLATE, TOE NAIL	3-8d (2 1/2" x 0.113")	----
2	CEILING JOISTS TO PLATE, TOE NAIL	3-8d (2 1/2" x 0.113")	----
3	CEILING JOIST NOT ATTACHED TO PARALLEL RAFTER, LAP OVER PARTITIONS, FACE NAIL	3-10d	----
4	COLLAR TIE RAFTER, FACE NAIL OR 1/2" x 20 GAGE RIDGE STRAP	3-10d (3" x 0.128")	----
5	RAFTER TO PLATE, TOE NAIL	2-16d (3/8" x 0.135")	----
6	ROOF RAFTERS TO RIDGE, VALLEY OR HIP RAFTERS: TOE NAIL, FACE NAIL	4-16d (3/8" x 0.135") 3-16d (3/8" x 0.135")	----
<b>WALL</b>			
7	BUILT-UP CORNER STUDS	10d (3" x 0.128")	24" o.c.
8	BUILT-UP HEADER, TWO PIECES WITH 1/2" SPACER	16d (3/8" x 0.135")	16" o.c. ALONG EACH EDGE
9	CONTINUED HEADER, TWO PIECES	16d (3/8" x 0.135")	16" o.c. ALONG EACH EDGE
10	CONTINUOUS HEADER TO STUD, TOE NAIL	4-8d (2 1/2" x 0.113")	----
11	DOUBLE STUDS, FACE NAIL	10d (3" x 0.128")	24" o.c.
12	DOUBLE TOP PLATES, FACE NAIL	10d (3" x 0.128")	24" o.c.
13	DOUBLE TOP PLATES, MINIMUM 48-INCH OFFSET OF END JOINTS, FACE NAIL IN LAPPED AREA	8-16d (3/8" x 0.135")	----
14	SOLE PLATE TO JOIST OR BLOCKING, FACE NAIL	16d (3/8" x 0.135")	16" o.c.
15	SOLE PLATE TO JOIST OR BLOCKING AT BRACED WALL PANELS	3-16d (3/8" x 0.135")	16" o.c.
16	STUD TO SOLE PLATE, TOE NAIL	3-8d (2 1/2" x 0.113") OR 2-16d (3/8" x 0.135")	----
17	TOP OR SOLE PLATE TO STUD, END NAIL	2-16d (3/8" x 0.135")	----
18	TOP PLATES, LAPS AT CORNERS AND INTERSECTIONS, FACE NAIL	3-10d (3" x 0.128")	----
19	1" BRACE TO EACH STUD AND PLATE, FACE NAIL	2-8d (2 1/2" x 0.113") 2 STAPLES 1 1/2"	----
20	1" x 6" SHEATHING TO EACH BEARING, FACE NAIL	2-8d (2 1/2" x 0.113") 2 STAPLES 1 1/2"	----
21	1" x 8" SHEATHING TO EACH BEARING, FACE NAIL	2-8d (2 1/2" x 0.113") 2 STAPLES 1 1/2"	----
22	WIDER THAN 1" x 8" SHEATHING TO EACH BEARING, FACE NAIL	3-8d (2 1/2" x 0.113") 3 STAPLES 1 1/2"	----
<b>FLOOR</b>			
23	JOIST TO SILL OR GIRDER, TOE NAIL	3-8d (2 1/2" x 0.113")	----
24	1" x 6" SUBFLOOR OR LESS TO EACH JOIST, FACE NAIL	2-8d (2 1/2" x 0.113") 2 STAPLES 1 1/2"	----
25	2" SUBFLOOR TO JOIST OR GIRDER, BLIND AND FACE NAIL	2-16d (3/8" x 0.135")	----
26	RIM JOIST TO TOP PLATE, TOE NAIL (ROOF APPLICATIONS ALSO)	8d (2 1/2" x 0.113")	6" o.c.
27	2" PLANKS (PLANK & BEAM - FLOOR & ROOF)	2-16d (3/8" x 0.135")	AT EACH BEARING
28	BUILT-UP GIRDERS AND BEAMS, 2 INCH LUMBER LAYERS	10d (3" x 0.128")	NAIL EACH LAYER AS FOLLOWS: 32" o.c. AT TOP AND BOTTOM AND STAGGERED, TWO NAILS AT ENDS AND AT EACH SPLICE.
29	LEDGER STRIP SUPPORTING JOISTS OR RAFTERS	3-16d (3/8" x 0.135")	AT EACH JOIST OR RAFTER

TABLE R602.3(1) - CONTINUED  
FASTENER SCHEDULE FOR STRUCTURAL MEMBERS

ITEM	DESCRIPTION OF BUILDING ELEMENTS	NUMBER AND TYPE OF FASTENER (*b,*c,*e)	SPACING OF FASTENERS
<b>WOOD STRUCTURAL PANELS, SUBFLOOR, ROOF AND INTERIOR WALL SHEATHING TO FRAMING AND PARTICLEBOARD WALL SHEATHING TO FRAMING</b>			
30	3/8" x 1/2"	6d common (2" x 0.113") nail (subfloor wall) <sup>g</sup> 8d common (2 1/2" x 0.131") nail (roof)	6 12" g
31	3/8" x 3/4"	6d common (2" x 0.113") nail (subfloor, wall) 8d common (2 1/2" x 0.131") nail (roof) <sup>g</sup>	6 12" g
32	1/2" x 1"	8d common (2 1/2" x 0.131")	6 12" g
33	1/2" x 1 1/4"	10d common (3" x 0.148") nail or 8d common (2 1/2" x 0.131") deformed nail	6 12
<b>OTHER WALL SHEATHING<sup>h</sup></b>			
34	1/2" STRUCTURAL CELLULOSIC FIBERBOARD SHEATHING	1/2" galvanized roofing nail, 7/16" crown or 1" crown staple 16ga., 1/2" long	3 6
35	3/8" STRUCTURAL CELLULOSIC FIBERBOARD SHEATHING	1 1/2" galvanized roofing nail, 7/16" crown or 1" crown staple 16ga., 1/2" long	3 6
36	1/2" GYPSUM SHEATHING <sup>d</sup>	1/2" galvanized roofing nail, staple galvanized, 1/2" long; 1/4" screws, Type W or S	7 7
37	3/8" GYPSUM SHEATHING <sup>d</sup>	1 1/2" galvanized roofing nail, staple galvanized, 1 1/2" long; 1 1/2" screws, Type W or S	7 7
<b>WOOD STRUCTURAL PANELS, COMBINATION SUBFLOOR UNDERLAYMENT TO FRAMING</b>			
38	3/4" AND LESS	6d deformed (2" x 0.120") nail or 8d common (2 1/2" x 0.131") nail	6 12
39	3/4"-1"	8d common (2 1/2" x 0.131") nail or 8d deformed (2 1/2" x 0.120") nail	6 12
40	1/2"-1 1/4"	10d common (3" x 0.148") nail or 8d deformed (2 1/2" x 0.120") nail	6 12

\*a - All nails are smooth-common, box or deformed shanks except where otherwise stated. Nails used for framing and sheathing connections have minimum average bending yield strengths as shown: 80 ksi for shank diameter of 0.192 inch (20d common nail), 90 ksi for shank diameters larger than 0.142 inch but not larger than 0.177 inch, and 100 ksi for shank diameters of 0.142 inches or less.  
\*b - Staples are 16 ga. wire and have a minimum 7/16 inch diameter crown width.  
\*c - Nails shall be spaced at not more than 6 inches on center at all supports where spans are 48 inches or greater.  
\*d - Four-foot-by-8-foot or 4-foot-by-9-foot panels shall be applied vertically.  
\*e - Spacing of fasteners not included in this table shall be based on Table R602.3(2).  
\*f - For regions having a basic wind speed of 110 mph or greater, 8d deformed (2 1/2" x 0.120") nails shall be used for attaching plywood and wood structural panel roof sheathing to framing within minimum 48-inch distance from gable end walls, if mean roof height is more than 25 feet, up to 35 feet maximum.  
\*g - For regions having a basic wind speed of 100 mph or less, nails for attaching wood structural panel roof sheathing to gable end wall framing shall be spaced 6 inches on center. When basic wind speed is greater than 100 mph, nails for attaching panel roof sheathing to intermediate supports shall be spaced 6 inches on center for minimum 48-inch distance from ridges, eaves and gable end walls; and 4 inches on center to gable end wall framing.  
\*h - Gypsum sheathing shall conform to ASTM C 1396 and shall be installed in accordance with GA 253. Fiberboard sheathing shall conform to ASTM C 208.  
\*i - Spacing of fasteners on floor sheathing panel edges applies to panel edges supported by framing members and required blocking and at all floor perimeters only. Spacing of fasteners on roof sheathing panel edges applies to panel edges supported by framing members and required blocking. Blocking of roof or floor sheathing panel edges perpendicular to the framing members need not be provided except as required by other provisions of this code. Floor perimeter shall be supported by framing members or solid blocking.

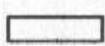
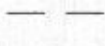

LINE TYPE KEY:  
NEW WALL   
ABOVE LINE   
FDN. WALL 

TABLE R602.10.4.1  
BRACING METHODS

METHOD	MATERIAL	MINIMUM THICKNESS	CONNECTION CRITERIA
CS-WSP	WOOD STRUCTURAL PANEL	3/8"	6d common (2" x 0.113") nails at 6" spacing (panel edges) and at 12" spacing (intermediate supports) or 16ga. x 1 1/2" staples at 3" spacing (panel edges) and 6" spacing (intermediate supports)
CS-G	WOOD STRUCTURAL PANEL ADJACENT TO GARAGE OPENINGS AND SUPPORTING ROOF LOAD ONLY <sup>a,b</sup>	3/8"	See Method CS-WSP
CS-PF	CONTINUOUS PORTAL FRAME	See Section R602.10.4.1.1	See section R602.10.4.1.1

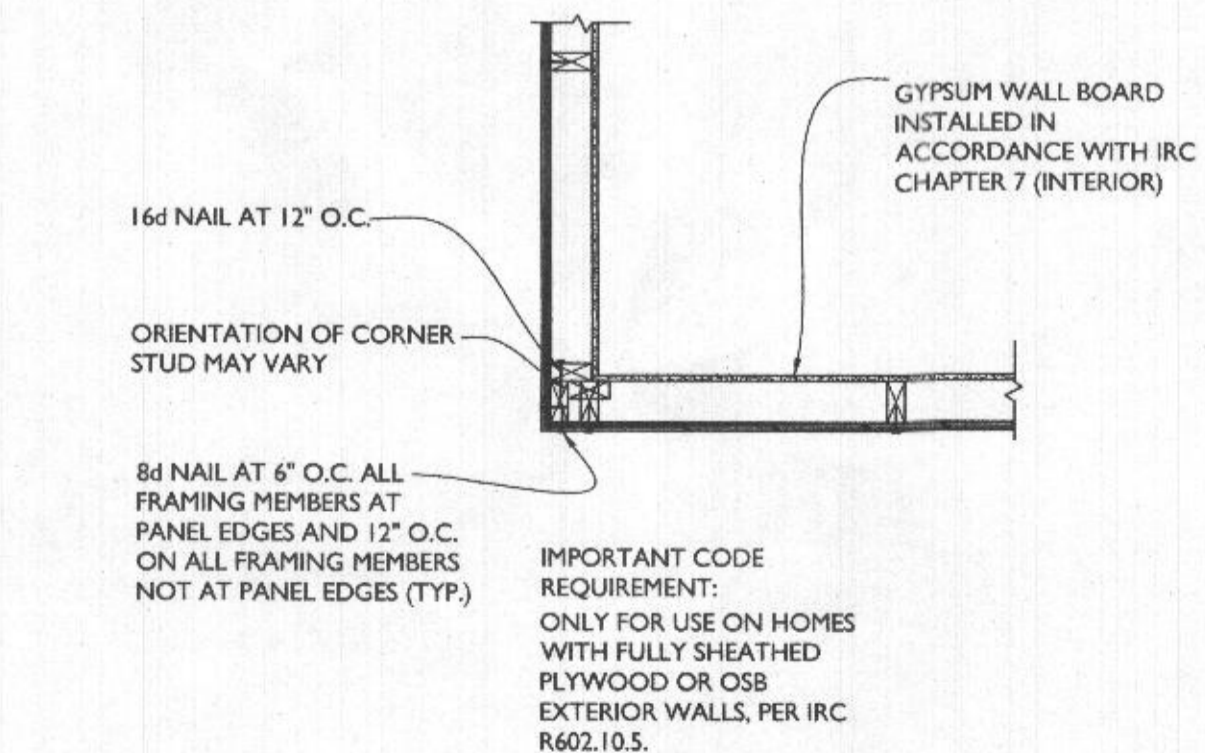
<sup>a</sup> - Applies to one wall of a garage only.  
<sup>b</sup> - Roof covering dead loads shall be 3 psf or less.

TABLE N102.4.1.1  
AIR BARRIER AND INSULATION INSPECTION

COMPONENT	CRITERIA
AIR BARRIER AND THERMAL BARRIER	EXTERIOR THERMAL ENVELOPE INSULATION FOR FRAMED WALLS IS INSTALLED IN SUBSTANTIAL CONTACT AND CONTINUOUS ALIGNMENT WITH BUILDING ENVELOPE AIR BARRIER. BREAKS OR JOINTS IN THE AIR BARRIER ARE FILLED OR REPAIRED. AIR-PERMEABLE INSULATION IS NOT USED AS A SEALING MATERIAL.
CEILING/ ATTIC	AIR BARRIER IN ANY DROPPED CEILING/ SOFFIT IS SUBSTANTIALLY ALIGNED WITH INSULATION AND ANY GAPS ARE SEALED. ATTIC ACCESS (EXCEPT UNVENTED ARRIC), KNEE WALL DOOR, OR DROP DOWN STAIR IS SEALED.
WALLS	CORNERS AND HEADERS ARE INSULATED. JUNCTION OF FOUNDATION AND SILL PLATE IS SEALED.
WINDOWS AND DOORS	SPACE BETWEEN WINDOW/ DOOR JAMBS AND FRAMING IS SEALED.
RIM JOISTS	RIM JOISTS ARE INSULATED AND INCLUDE AN AIR BARRIER.
FLOORS (including above garage and cantilevered floors)	INSULATION IS INSTALLED TO MAINTAIN PERMANENT CONTACT WITH UNDERSIDE OF SUBFLOOR DECKING. AIR BARRIER IS INSTALLED AT ANY EXPOSED EDGE OF FLOOR.
CRAWLSPACE WALLS	INSULATION IS PERMANENTLY ATTACHED TO WALLS. EXPOSED EARTH IN UNVENTED CRAWLSPACES IS COVERED WITH CLASS I VAPOR RETARDER WITH OVERLAPPING JOINTS TAPED.
SHAFTS, PENETRATIONS	DUCT SHAFTS, UTILITY PENETRATIONS, KNEE WALLS AND FLUE SHAFTS OPENING TO EXTERIOR OR UNCONDITIONED SPACE ARE SEALED.
NARROW CAVITIES	BATTS IN NARROW CAVITIES ARE CUT TO FIT, OR NARROW CAVITIES ARE FILLED BY SPRAYED/ BLOWN INSULATION.
GARAGE SEPARATION	AIR SEALING IS PROVIDED BETWEEN THE GARAGE AND CONDITIONED SPACES.
RECESSED LIGHTING	RECESSED LIGHT FIXTURES ARE AIRTIGHT, IC RATED AND SEALED TO DRYWALL EXCEPTION --- FIXTURES IN CONDITIONED SPACE.
PLUMBING AND WIRING	INSULATION IS PLACED BETWEEN OUTSIDE AND PIPED. BATT INSULATION IS CUT TO FIT AROUND WIRING AND PLUMBING, OR SPRAYED/BLOWN INSULATION EXTENDS BEHIND PIPING AND WIRING.
SHOWER/TUB ON EXTERIOR WALL	SHOWERS AND TUBS ON EXTERIOR WALLS HAVE INSULATION AND AN AIR BARRIER SEPARATING THEM FROM THE EXTERIOR WALL.
ELECTRICAL/PHONE BOX ON EXTERIOR WALL	AIR BARRIER EXTENDS BEHIND BOXES OR AIR SEALED TYPE BOXES ARE INSTALLED.
COMMON WALL	AIR BARRIER IS INSTALLED IN COMMON WALL BETWEEN DWELLING UNITS.
HVAC REGISTER BOOTS	HVAC REGISTER BOOTS THAT PENETRATE BUILDING ENVELOPE ARE SEALED TO SUBFLOOR OR DRYWALL.
FIREPLACE	FIREPLACE WALLS INCLUDE AN AIR BARRIER.

PRESCRIPTIVE COMPONENT REQUIREMENTS - METHOD 1

BASED ON R-VALUES OR U-FACTORS  
1. THE EXACT LOCATION OF ALL OF THE BUILDING THERMAL ENVELOPE SHALL BE MARKED OUT ON THE PLANS, DETAILS, AND CROSS-SECTIONS.  
2. PROVIDE ALL INSULATION R-VALUES OR U-FACTORS, MATERIAL, AND LOCATIONS TO BE INSTALLED (WALLS, CEILINGS, CANTILEVER FLOORS, FLOORS OVER GARAGE, CRAWL SPACE, BASEMENT WALLS, ETC.) PER TABLES 402.1 OR 402.1.3 OR 402.2.5 FOR STEEL-FRAMED CONSTRUCTION.  
3. PROVIDE ALL FENESTRATION U-FACTORS FOR ALL GLAZING FOR EACH WINDOW AND DOOR PER TABLE 402.1.1 (SCHEDULE SUPPLIED BY DESIGNER).  
4. INDICATE HOW ALL AREAS LISTED IN SECTION 402.4.2 (TABLE) WILL BE PROTECTED AGAINST AIR LEAKAGE.  
5. INDICATE IF CRAWLSPACE(S) ARE CONDITIONED OR VENTED, MUST HAVE VAPOR BARRIER IF CONDITIONED.  
6. INDICATE DUCT INSULATION R-VALUES, MINIMUM R-6, R-8 IN ATTICS.  
7. INDICATE DUCT SEALING METHODS PER IRC M1601.4.1  
8. INDICATE LOCATION OF HVAC EQUIPMENT ON PLANS (INSIDE OR OUTSIDE THE ENVELOPE)


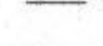


OUTSIDE CORNER DETAIL  
PER IRC R602.10.5

SCALE: 3/4"=1'-0"

WALL BRACING NEEDED & PROVIDED  
IRC R602.10.4 WALL BRACING METHOD  
BRACED PANEL MIN WIDTH FOR 9' H. CLG = 27"  
CS-PF MIN WIDTH FOR 10' CLG = 20"

BRACING NEEDED	BRACING PROVIDED
1ST FLOOR - 19'-6" WALL 'A' BRACING NEEDED: 6.5 x .95 = 6.175' MIN. BRACING PROVIDED: 6'-9"	2ND FLOOR - 32'-2" WALL 'F' BRACING NEEDED: 4.5 x .95 = 4.275' BRACING PROVIDED: 9'-0"
1ST FLOOR - 21'-8" WALL 'B' BRACING NEEDED: 6.5 x .95 = 6.175' MIN. BRACING PROVIDED: 10'-3"	2ND FLOOR - 35'-2" WALL 'G' BRACING NEEDED: 4.5 x .95 = 4.275' BRACING PROVIDED: 9'-0"
1ST FLOOR - 35'-2" WALL 'C' BRACING NEEDED: 11.5 x .95 = 10.925' MIN. BRACING PROVIDED: 13'-6"	2ND FLOOR - 37'-9" WALL 'H' BRACING NEEDED: 7.5 x .95 = 7.125' BRACING PROVIDED: 12'-5"
1ST FLOOR - WALL 'D' PORTAL FRAMING PROVIDED: 5'-0" W/ 20" PANELS	2ND FLOOR - 37'-9" WALL 'B' BRACING NEEDED: 7.5 x .95 = 7.125' BRACING PROVIDED: 13'-6"
1ST FLOOR - 27'-9" WALL 'E' BRACING NEEDED: 9 x .95 = 8.55' BRACING PROVIDED: 16'-0"	
1ST FLOOR - 52'-9" WALL 'I' BRACING NEEDED: 14.0 x .95 = 13.3' BRACING PROVIDED: 15'-0"	
1ST FLOOR - 12'-6" WALL 'J' BRACING NEEDED: 3.5 x .95 = 3.325' BRACING PROVIDED: 4'-6"	
1ST FLOOR - 12'-6" WALL 'K' PORTAL FRAMING PROVIDED: 3'-4" W/ 20" PANELS	
1ST FLOOR - 20'-9" WALL 'L' BRACING NEEDED: 6.5 x .95 = 6.175' BRACING PROVIDED: 7'-6"	
1ST FLOOR - 52'-9" WALL 'S' BRACING NEEDED: 20 x .95 = 19.0' BRACING PROVIDED: 29.75'	
1ST FLOOR - 32'-0" WALL 'G' BRACING NEEDED: 9.0 x .95 = 8.55' BRACING PROVIDED: 9'-0"	

 BRACED WALL PANEL  
 WOOD STRUCTURAL PANEL (UNLESS OTHERWISE NOTED)

CAIRN  
custom homes

TRANSFORMING  
ARCHITECTURE  
CUSTOM DESIGN. FLAT FEE.

7612 Browns Bridge Road  
Highland, MD 20777  
301-776-2666  
info@TransformingArchitecture.com  
www.TransformingArchitecture.com



STAMP

I CERTIFY THAT THESE DOCUMENTS WERE PREPARED OR APPROVED BY ME, AND THAT I AM A DULY LICENSED ARCHITECT UNDER THE LAWS OF THE STATE OF MARYLAND, LICENSE NUMBER 13662, EXPIRATION 10-22-2021.

NOTE: THESE DRAWINGS ARE THE PROPERTY OF TRANSFORMING ARCHITECTURE AND, AS SUCH, MAY NOT BE RE-USED OR REPRODUCED, EITHER WHOLLY OR IN PART, WITHOUT PRIOR WRITTEN CONSENT OF TRANSFORMING ARCHITECTURE.

PROJECT PHASE


PERMIT

PROJECT TITLE

THE  
WIZZARD  
RESIDENCE

1608 Florence Road  
MT AIRY, MD 21771

REVISIONS

SYMBOL	DATE	ISSUED FOR
	09/14/2021	BUILDING PLAN REVIEW

PROJECT NUMBER 21-594

DATE 07/16/2021




SCALE AS NOTED


DRAWING TITLE

LATERAL  
BRACING CALCS

SHEET NUMBER

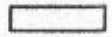
A-106

LINE TYPE KEY:  
 NEW WALL   
 ABOVE LINE   
 FDN. WALL 

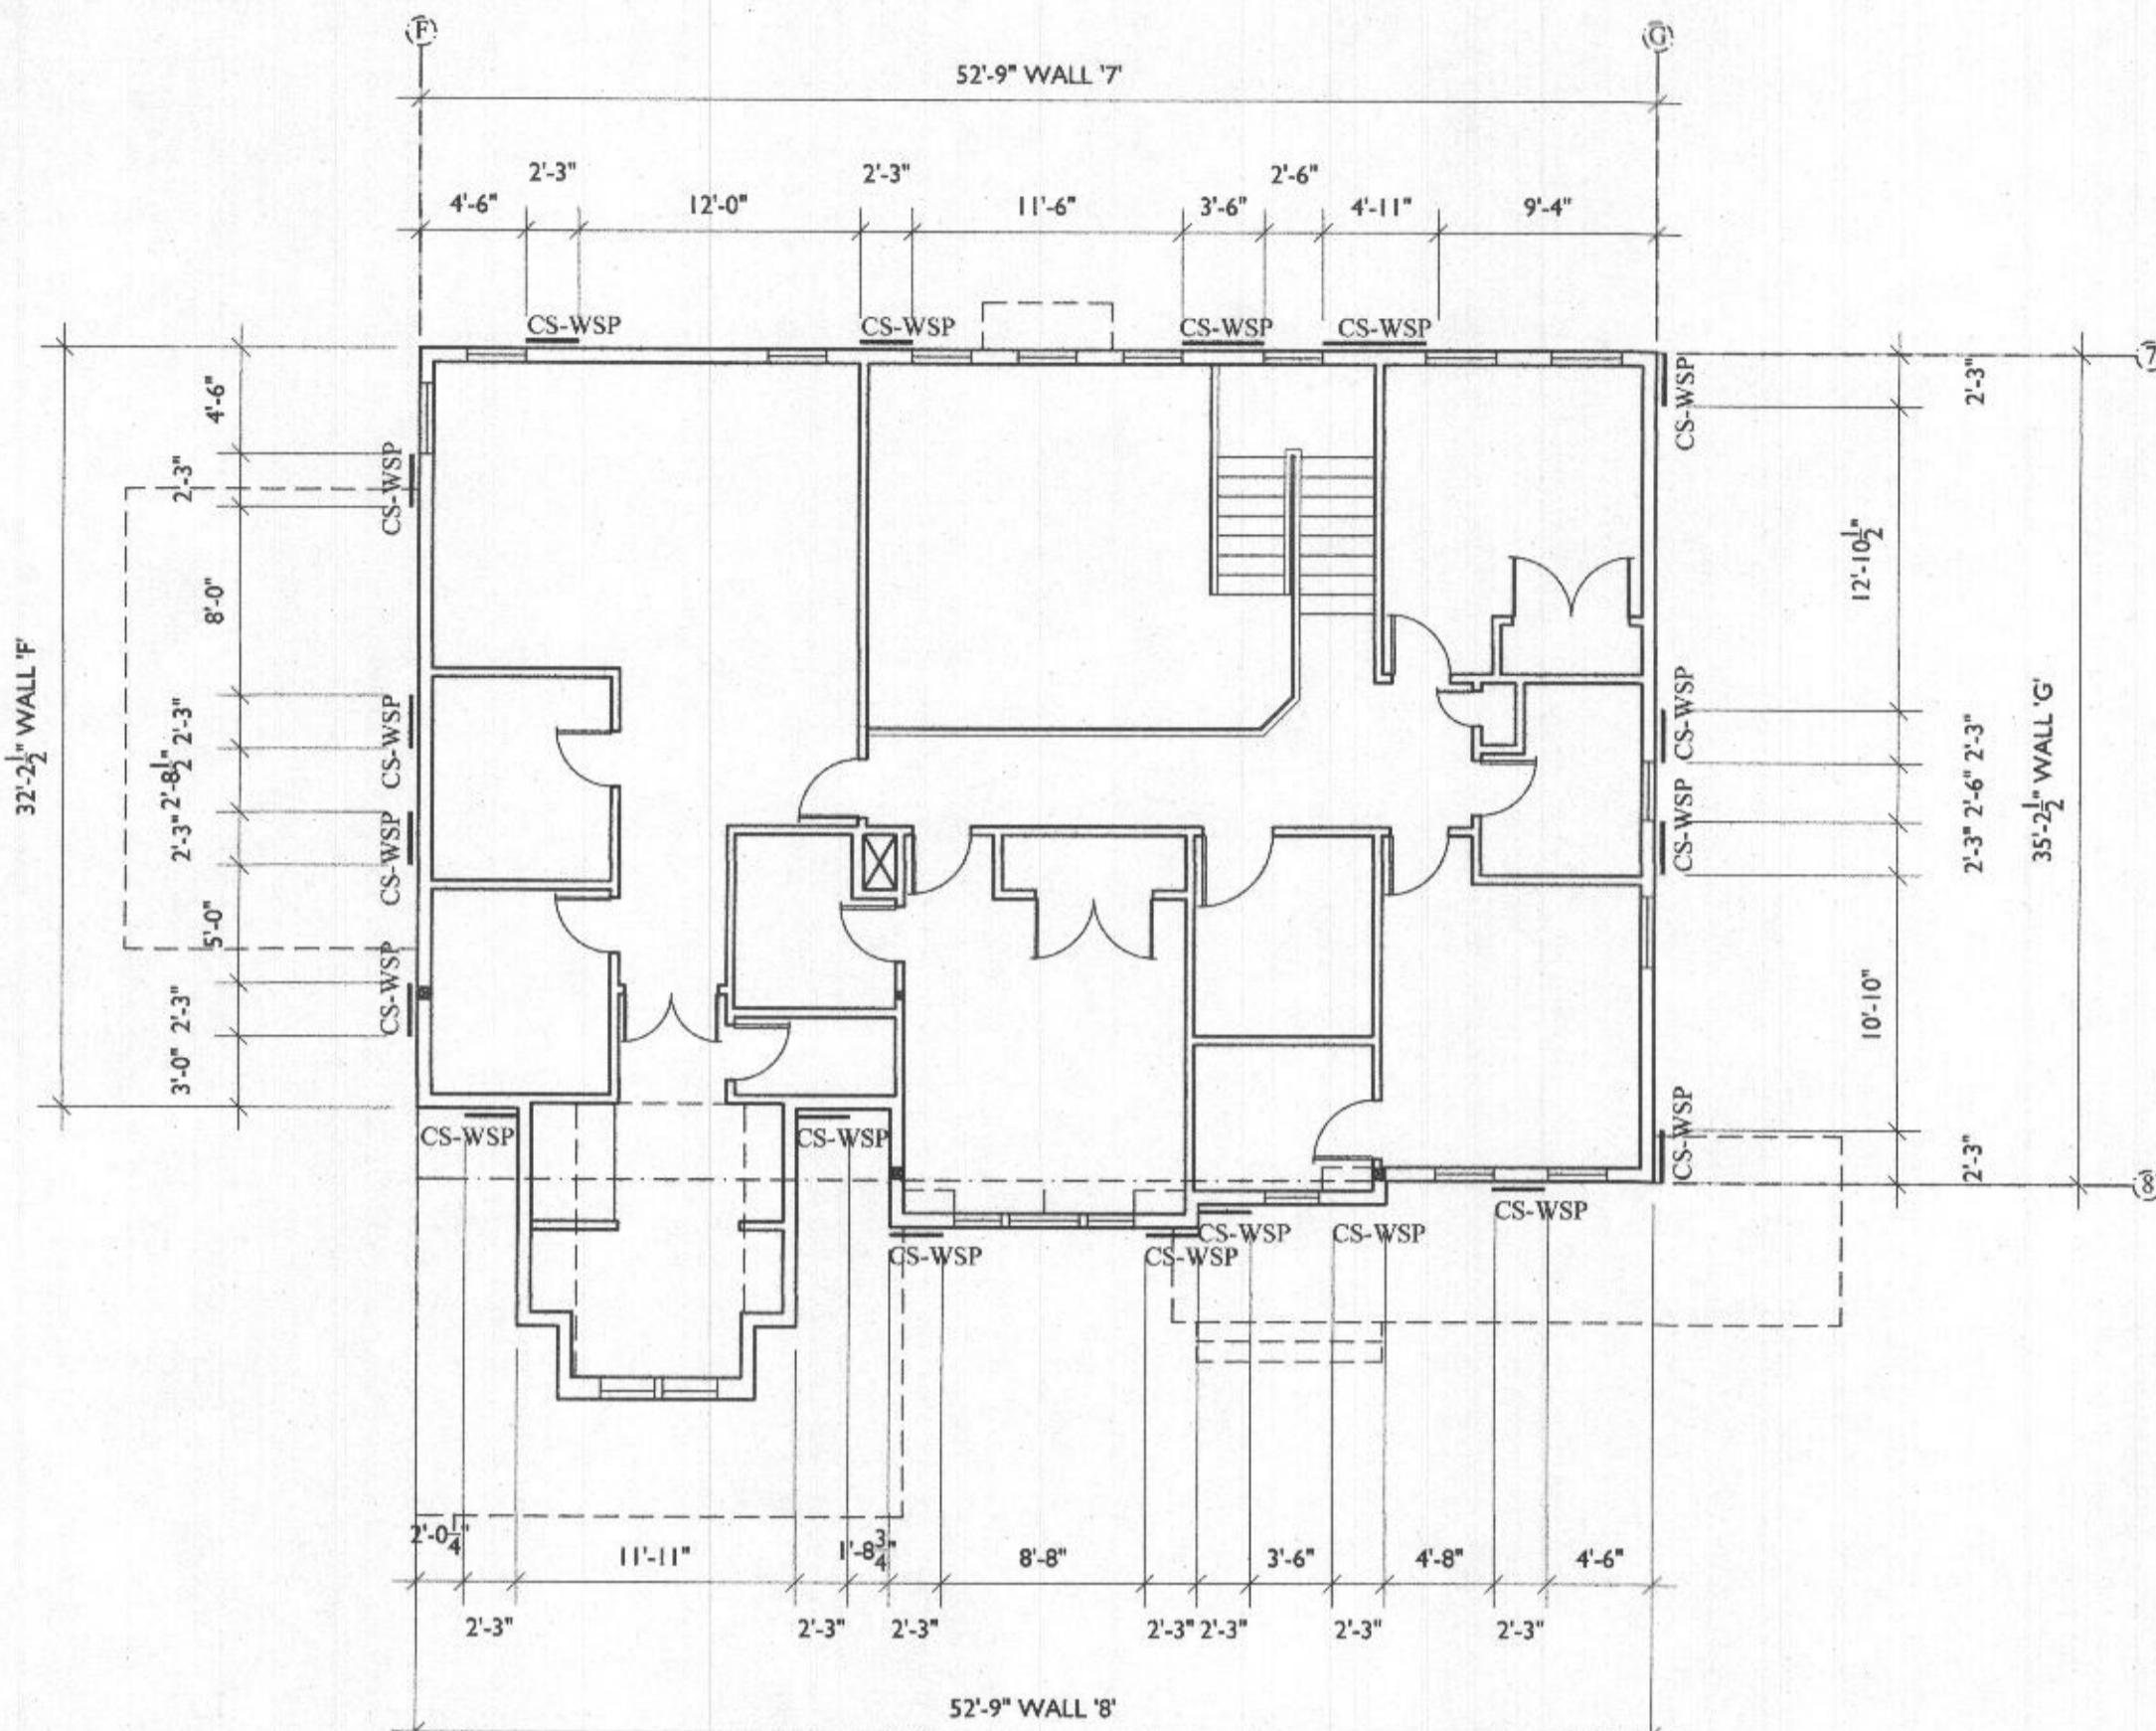


**SECOND FLOOR LATERAL BRACING**

SCALE: 1/8"=1'-0"

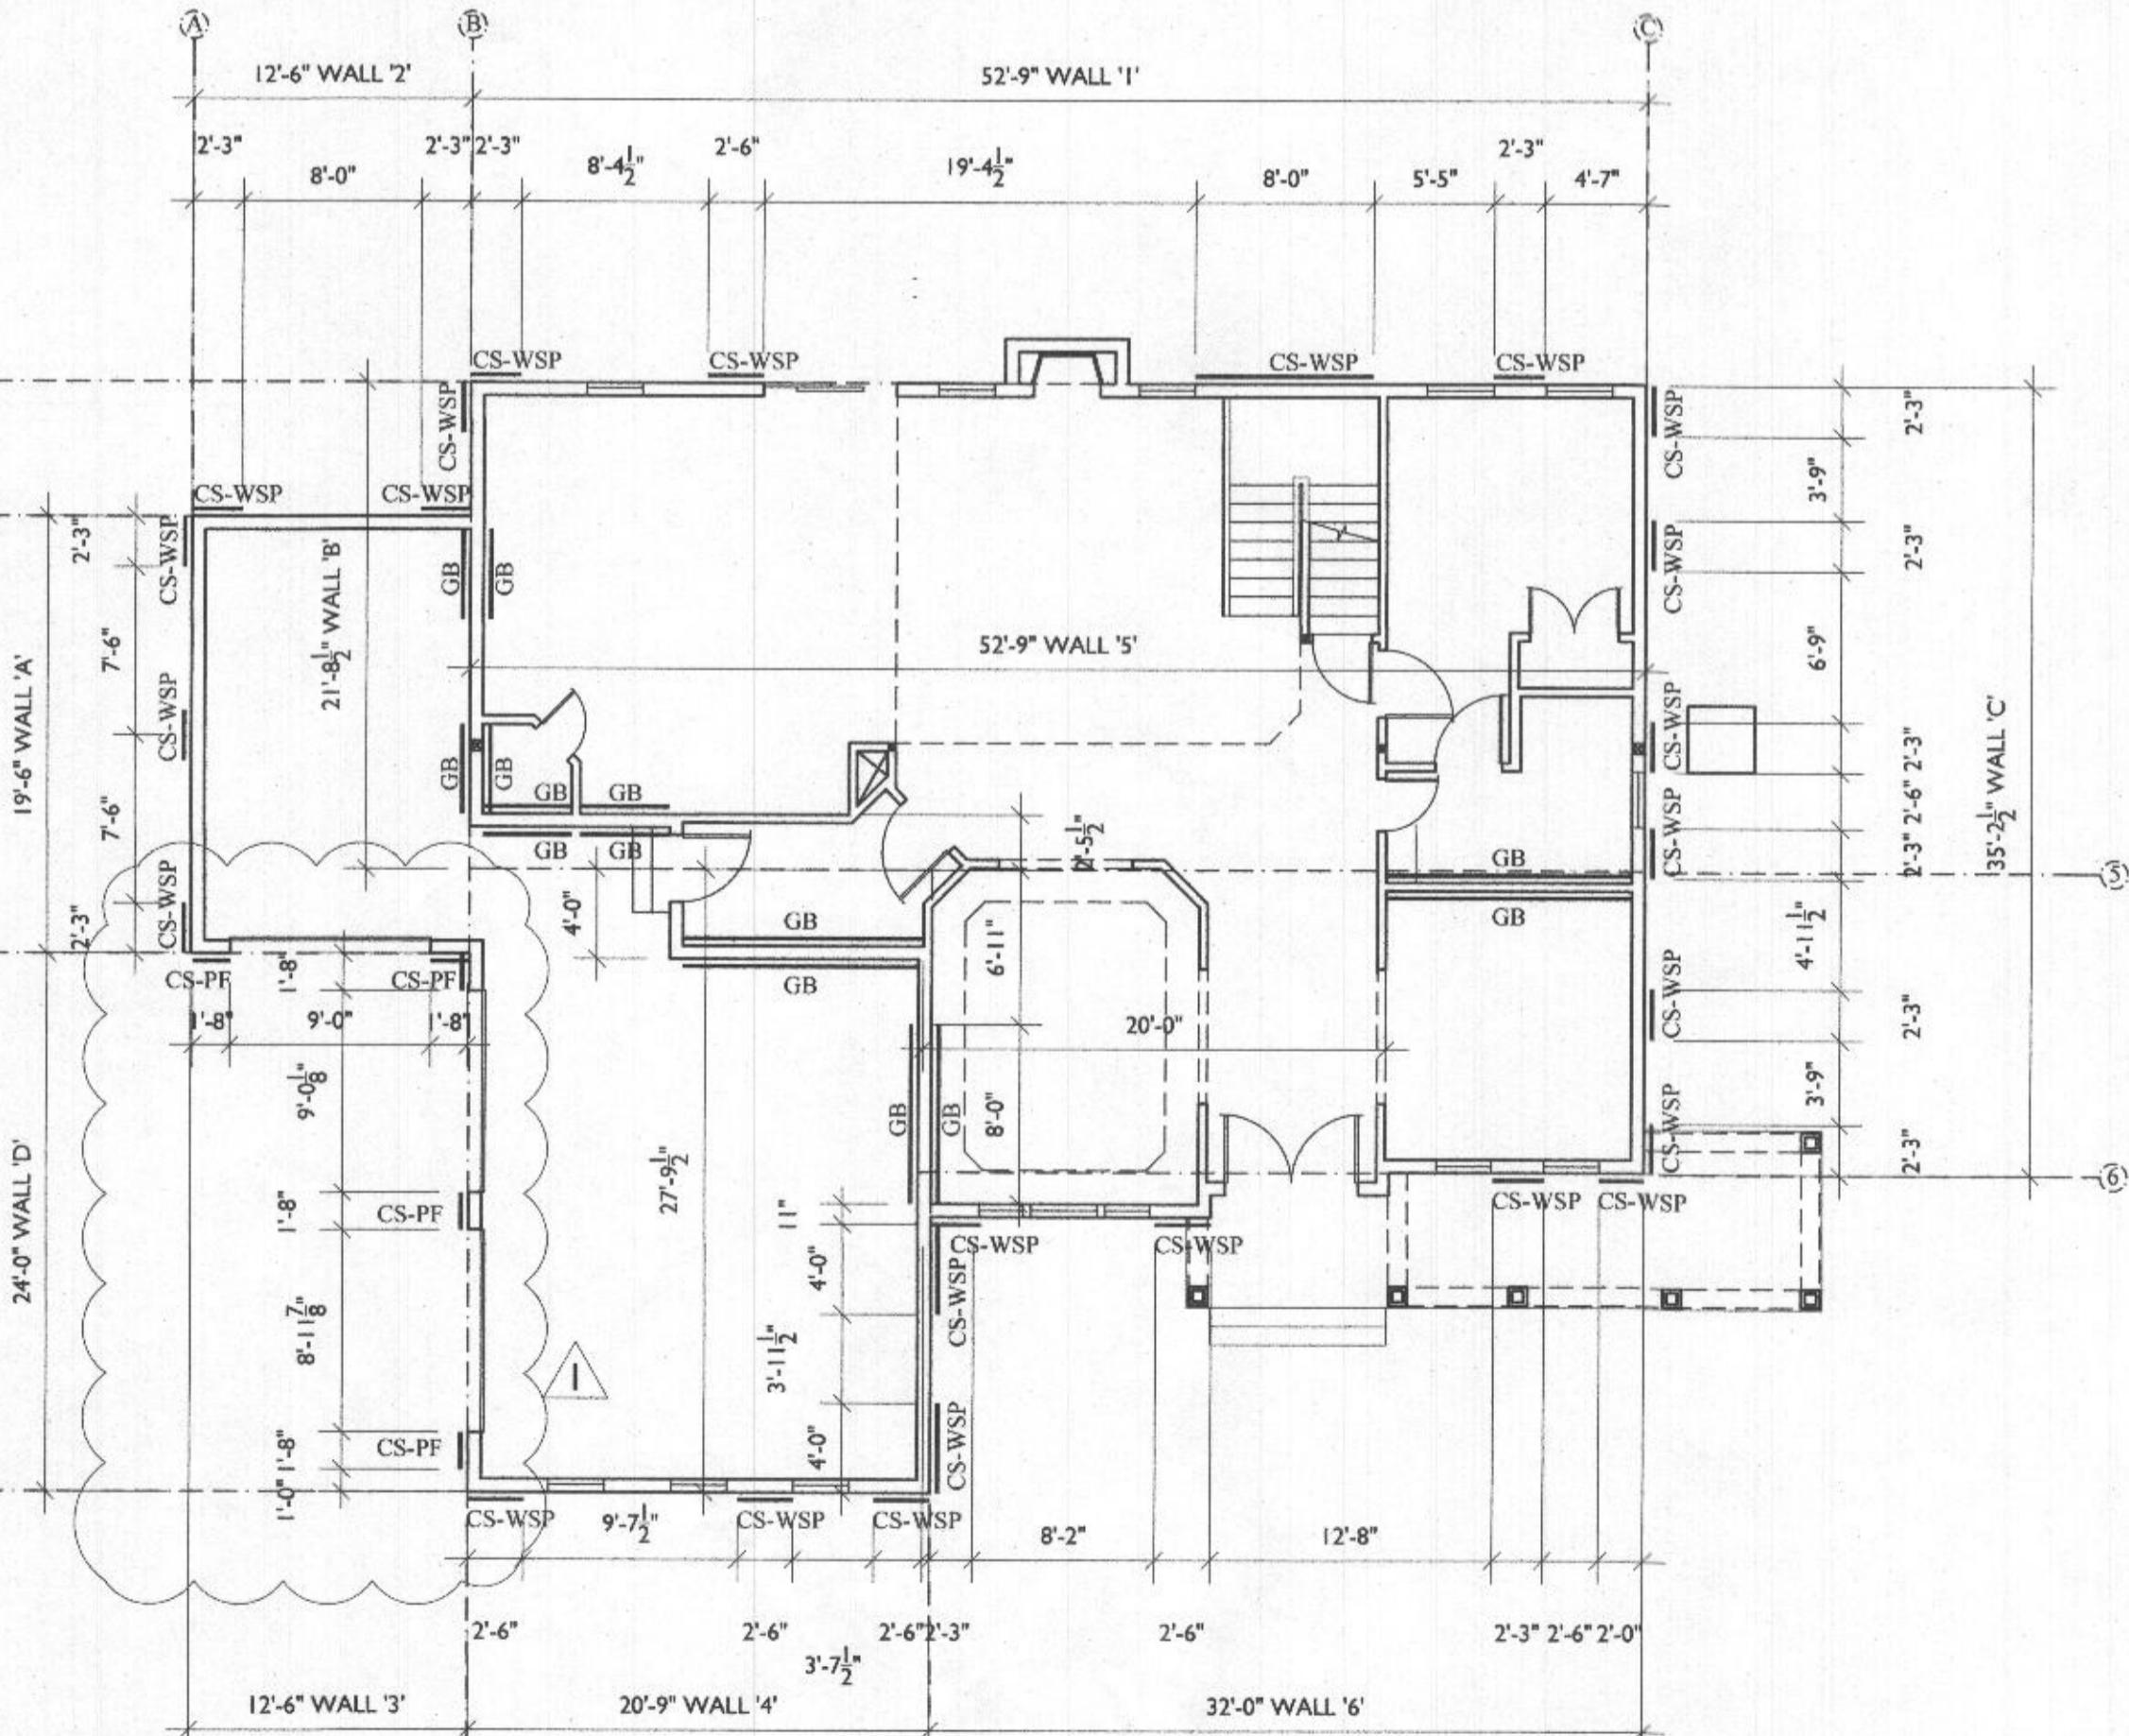



**FIRST FLOOR LATERAL BRACING**

SCALE: 1/8"=1'-0"

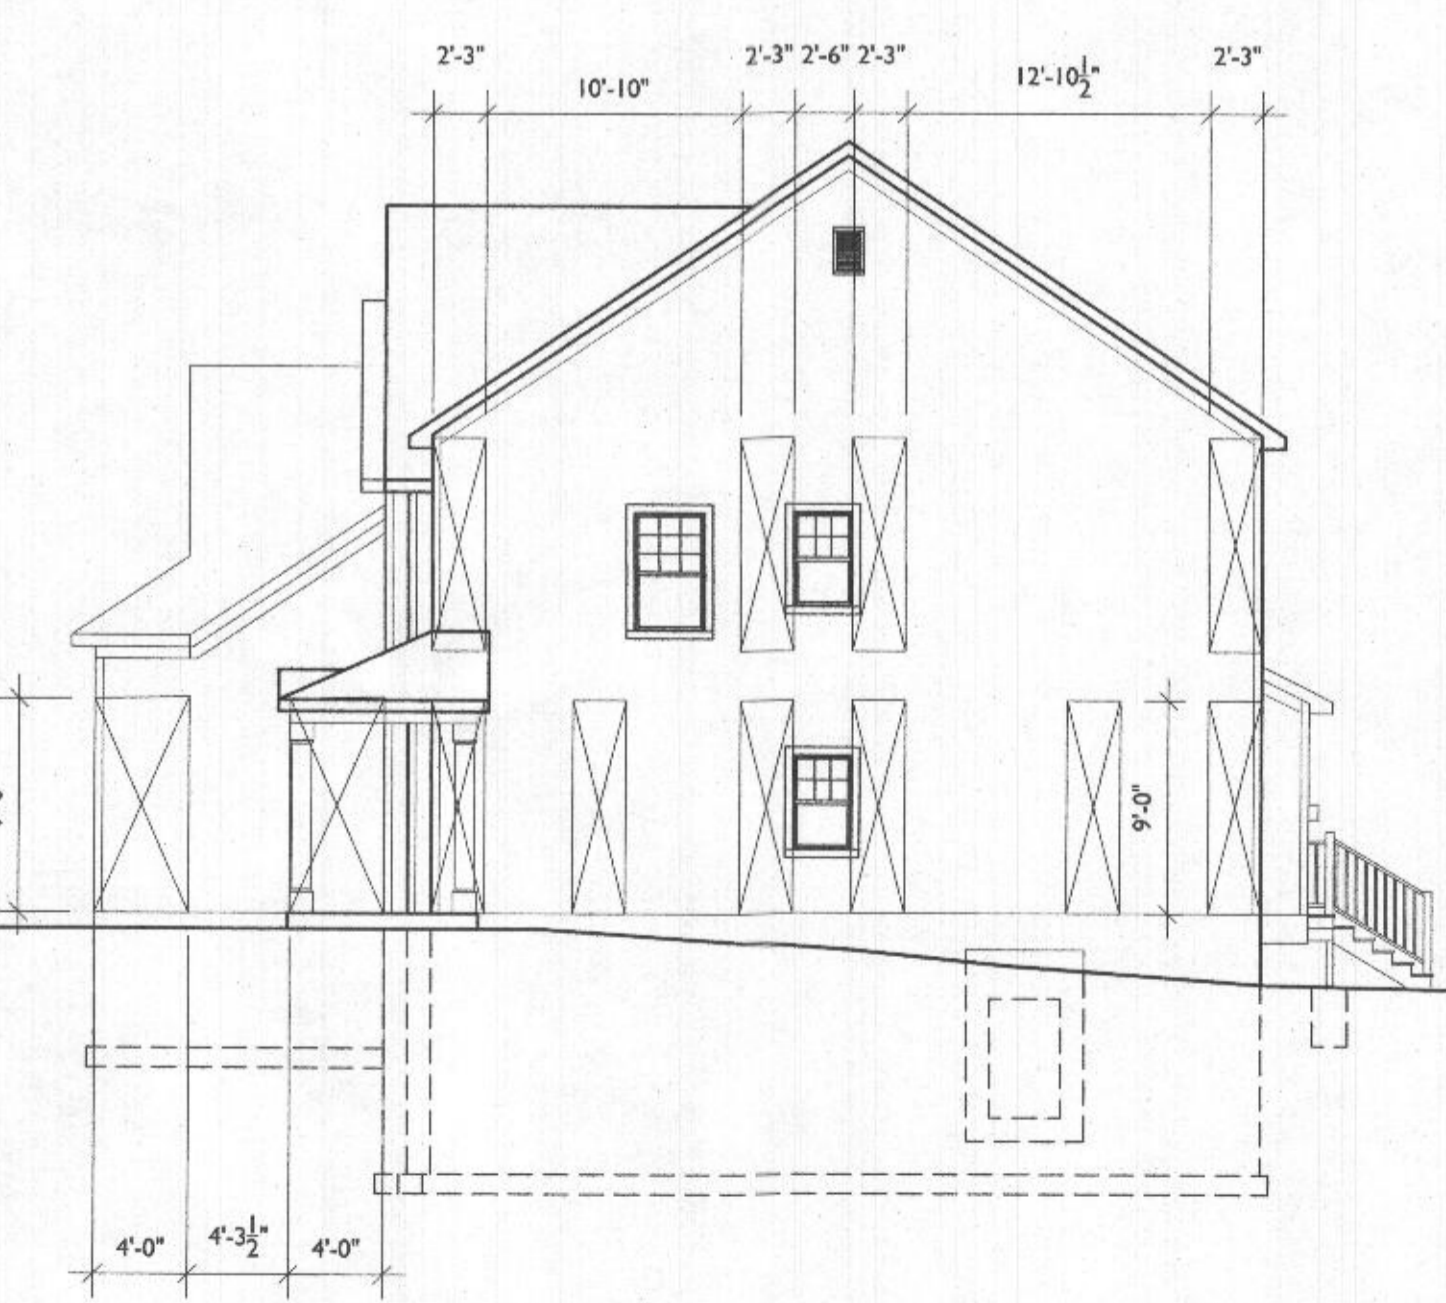

**LATERAL BRACING ELEVATIONS**

SCALE: 1/8"=1'-0"

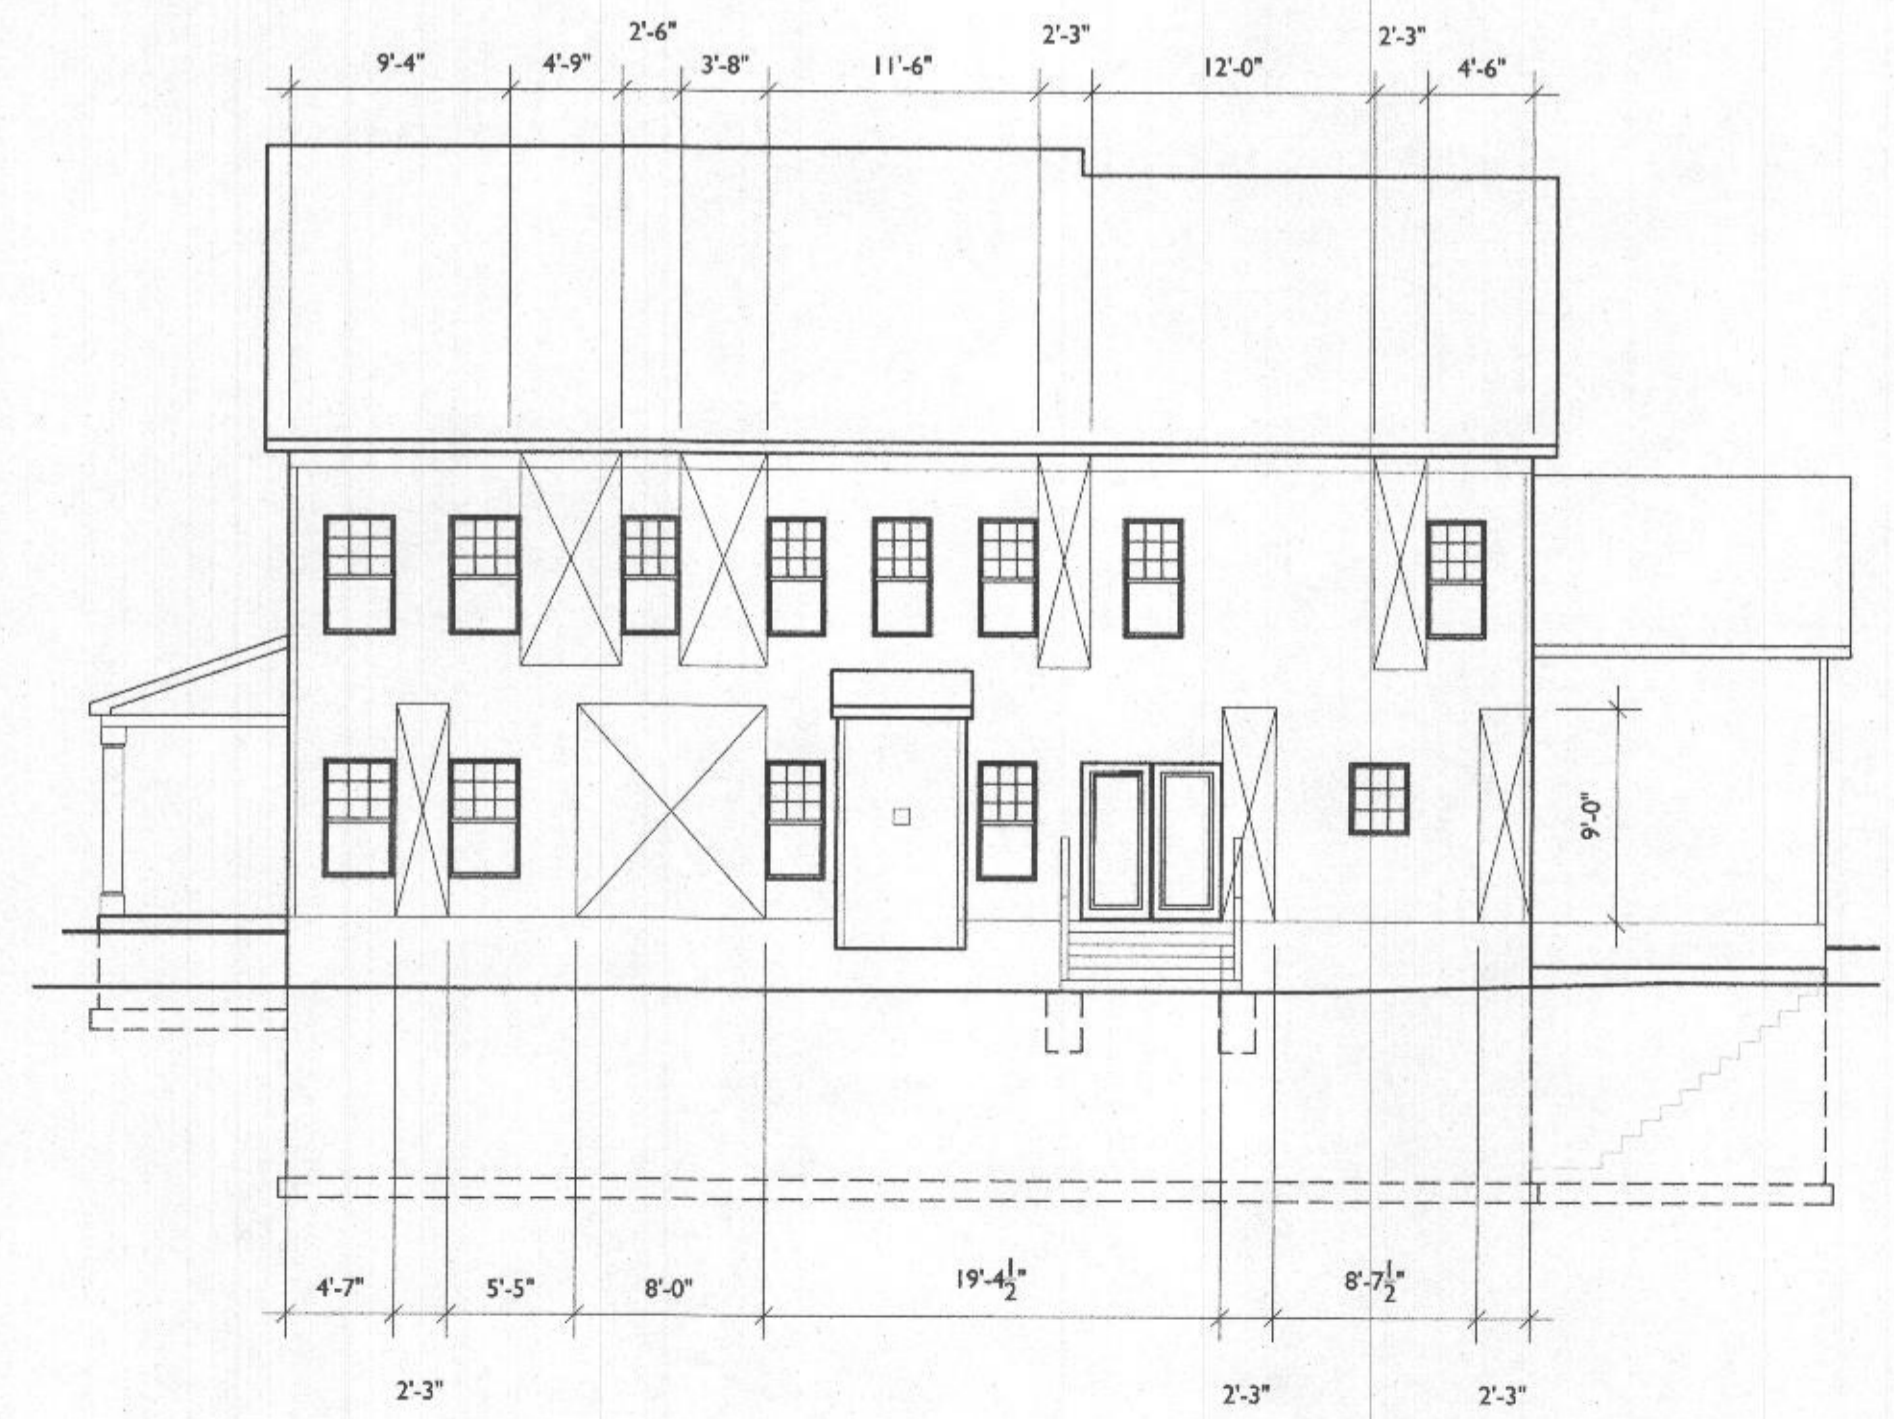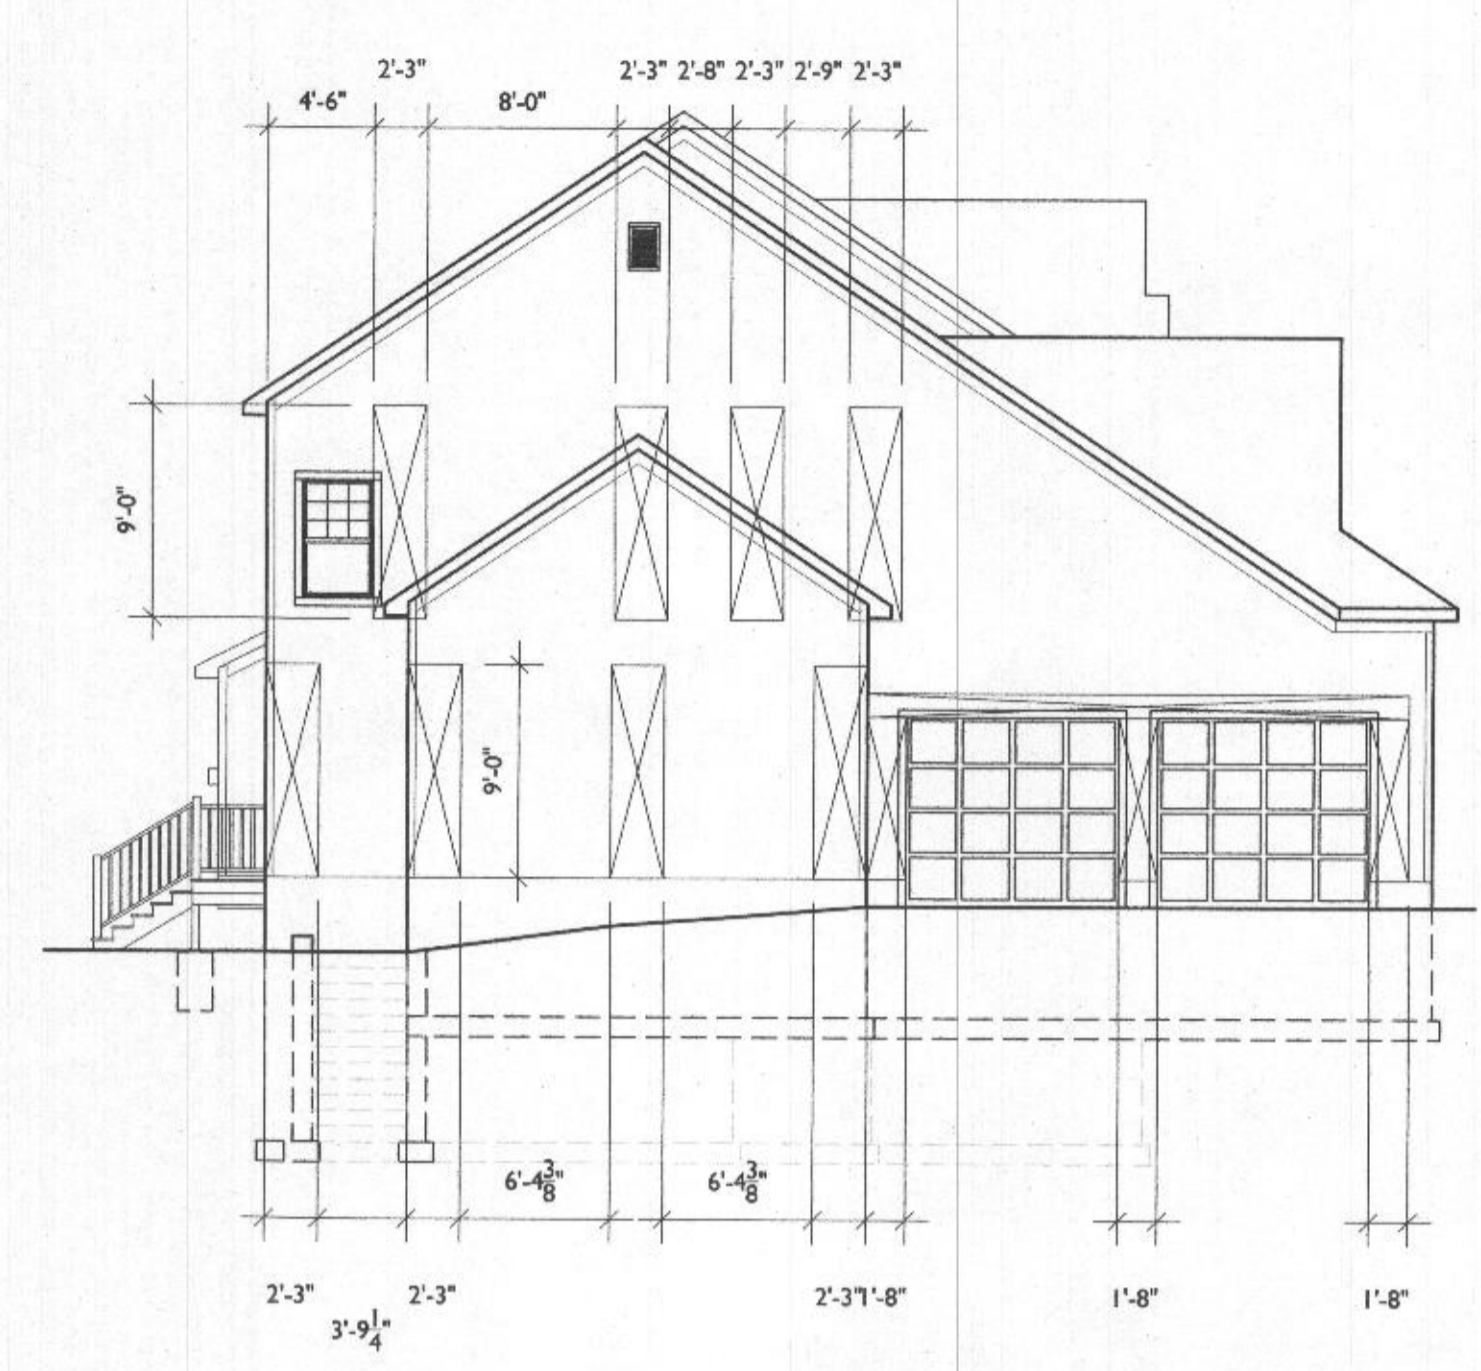

7612 Browns Bridge Road  
 Highland, MD 20777  
 301-776-2666  
 info@TransformingArchitecture.com  
 www.TransformingArchitecture.com



STAMP

I CERTIFY THAT THESE DOCUMENTS WERE PREPARED OR APPROVED BY ME, AND THAT I AM A DULY LICENSED ARCHITECT UNDER THE LAWS OF THE STATE OF MARYLAND. LICENSE NUMBER 13662. EXPIRATION 10-22-2021.

NOTE: THESE DRAWINGS ARE THE PROPERTY OF TRANSFORMING ARCHITECTURE AND, AS SUCH, MAY NOT BE RE-USED OR REPRODUCED, EITHER WHOLLY OR IN PART, WITHOUT PRIOR WRITTEN CONSENT OF TRANSFORMING ARCHITECTURE.

PROJECT PHASE  
**PERMIT**

PROJECT TITLE  
**THE WIZZARD RESIDENCE**

1608 Florence Road  
 MT AIRY, MD 21771




REVISIONS

SYMBOL	DATE	ISSUED FOR
▲	09/14/2021	BUILDING PLAN REVIEW

PROJECT NUMBER 21-594  
 DATE 07/16/2021  
 SCALE AS NOTED


DRAWING TITLE  
**LATERAL BRACING PLANS + ELEVS**

SHEET NUMBER  
**A-107**

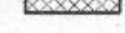LINE TYPE KEY:  
 NEW WALL:   
 ABOVE LINE:   
 FDN. WALL: 



1 FRONT ELEVATION  
 A200 SCALE: 1/4"=1'-0"

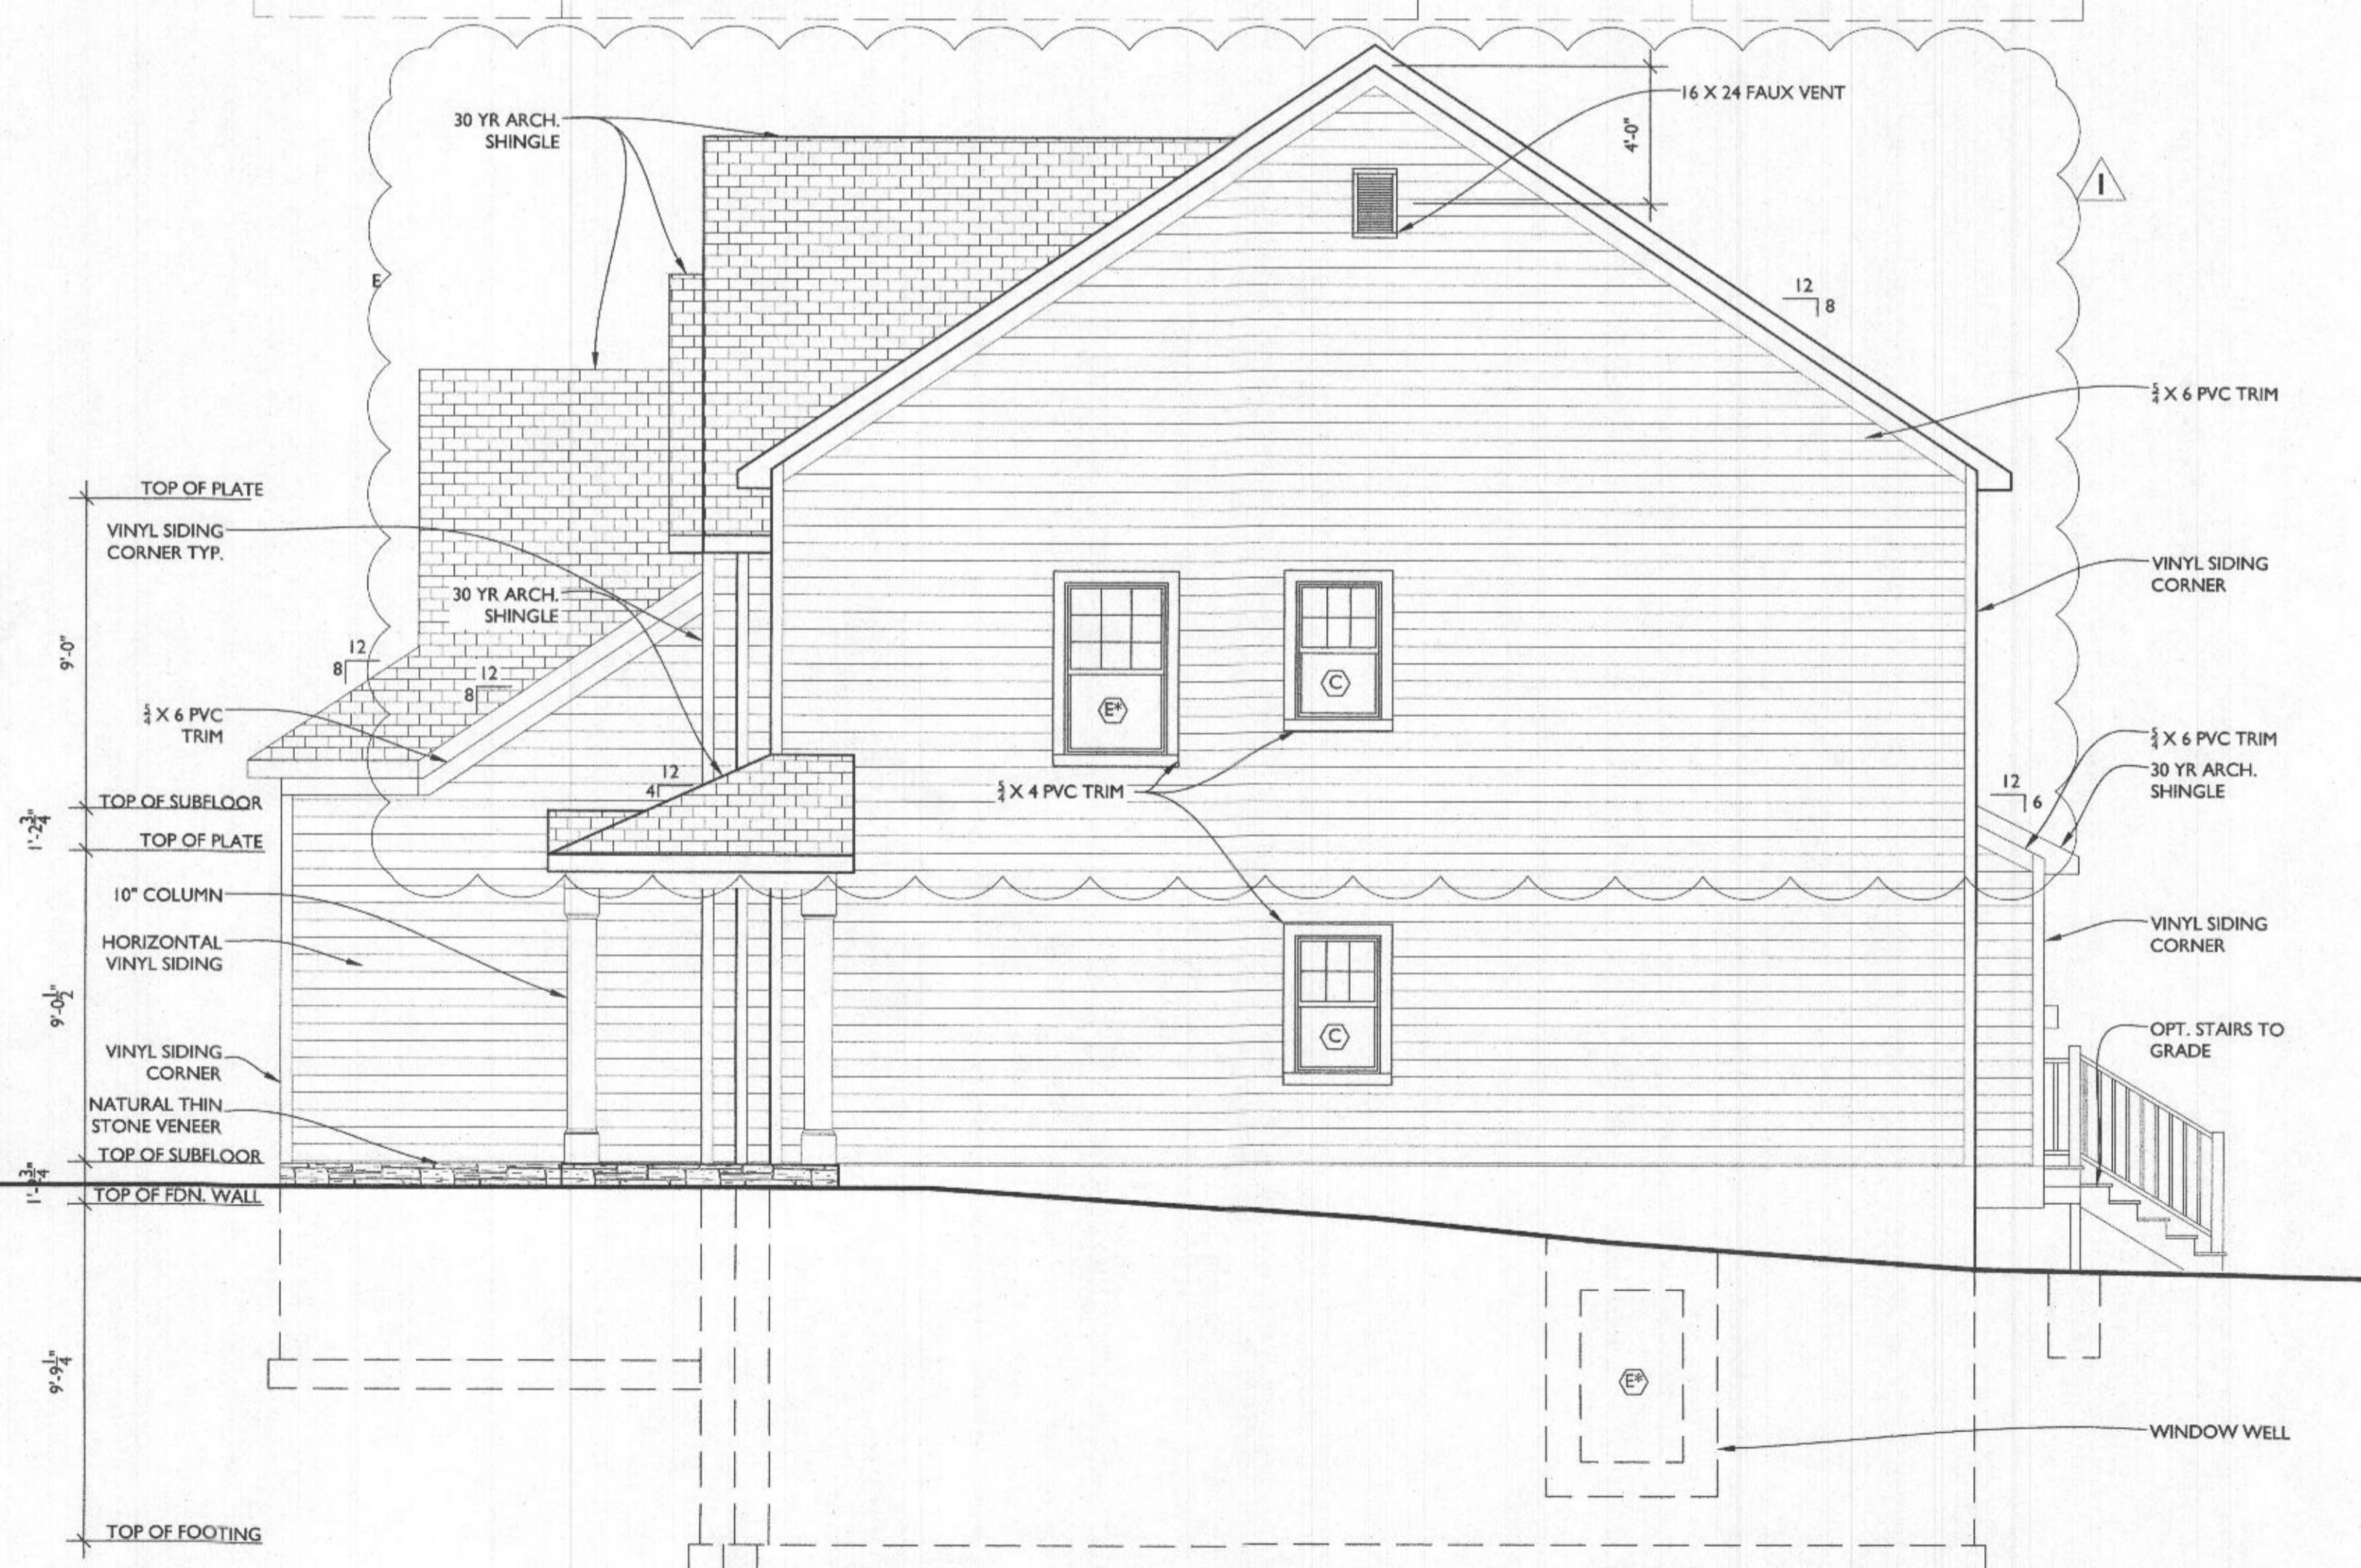

2 RIGHT ELEVATION  
 A200 SCALE: 1/4"=1'-0"



7613 Browns Bridge Road  
 Highland, MD 20777  
 301-776-2666  
 info@TransformingArchitecture.com  
 www.TransformingArchitecture.com



STAMP

I CERTIFY THAT THESE DOCUMENTS WERE PREPARED OR APPROVED BY ME, AND THAT I AM A DULY LICENSED ARCHITECT UNDER THE LAWS OF THE STATE OF MARYLAND, LICENSE NUMBER 13662, EXPIRATION 10-22-2021.

NOTE: THESE DRAWINGS ARE THE PROPERTY OF TRANSFORMING ARCHITECTURE AND, AS SUCH, MAY NOT BE RE-USED OR REPRODUCED, EITHER WHOLLY OR IN PART, WITHOUT PRIOR WRITTEN CONSENT OF TRANSFORMING ARCHITECTURE.

PROJECT PHASE

PERMIT

PROJECT TITLE

THE WIZZARD RESIDENCE

1608 Florence Road  
 MT AIRY, MD 21771

REVISIONS

SYMBOL	DATE	ISSUED FOR
1	09/14/2021	BUILDING PLAN REVIEW

PROJECT NUMBER 21-594

DATE 07/16/2021




SCALE AS NOTED

DRAWING TITLE

EXTERIOR ELEVATIONS

SHEET NUMBER

A-200

LINE TYPE KEY:  
 NEW WALL   
 ABOVE LINE   
 FDN. WALL 



**1 BACK ELEVATION**  
 SCALE: 1/4"=1'-0"



**2 LEFT ELEVATION**  
 SCALE: 1/4"=1'-0"



7612 Browns Bridge Road  
 Highland, MD 20777  
 301-776-2666  
 info@TransformingArchitecture.com  
 www.TransformingArchitecture.com



I CERTIFY THAT THESE DOCUMENTS WERE PREPARED OR APPROVED BY ME, AND THAT I AM A DULY LICENSED ARCHITECT UNDER THE LAWS OF THE STATE OF MARYLAND, LICENSE NUMBER 13662, EXPIRATION 10-22-2021.

NOTE: THESE DRAWINGS ARE THE PROPERTY OF TRANSFORMING ARCHITECTURE AND, AS SUCH, MAY NOT BE RE-USED OR REPRODUCED, EITHER WHOLLY OR IN PART, WITHOUT PRIOR WRITTEN CONSENT OF TRANSFORMING ARCHITECTURE.

PROJECT PHASE  
**PERMIT**

PROJECT TITLE  
**THE WIZZARD RESIDENCE**  
 1608 Florence Road  
 MT AIRY, MD 21771

REVISIONS		
SYMBOL	DATE	ISSUED FOR
1	09/14/2021	BUILDING PLAN REVIEW

PROJECT NUMBER 21-594  
 DATE 07/16/2021  
 SCALE AS NOTED

DRAWING TITLE  
**EXTERIOR ELEVATIONS**

SHEET NUMBER  
**A-201**