

Canapp Residence Renovation/Addition

6501 Heather Glen Way
Clarksville, MD 21029



OWNER

Sherman Canapp Jr.
Debra Canapp
6501 Heather Glen Way
Clarksville, MD 21029

CONTACT

Sherman Canapp Jr., DVM
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Debra Canapp, DVM
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ARCHITECT

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CONTACT

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CONTACT

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6339 Howard Lane
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CONTACT

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Renovation/Addition
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No.	Issue / Revision	Date
	ISSUED FOR PERMIT	01.21.21
	ISSUED FOR PERMIT	12.29.20
	ISSUED FOR REVIEW	12.21.20
	ISSUED FOR REVIEW	12.07.20
	ISSUED FOR REVIEW	11.17.20
Drawn By:		M.B.
Checked By:		R. P.
Checked By:		
Plot Date:		

Sheet Number
A0.1

Sheet Title
Cover Sheet

PROJECT DATA

SITE ADDRESS
6501 HEATHER GLEN WAY
CLARKSVILLE, MD 21029

LOT SIZE: 3.0559 ACRES
LOT 7, BLOCK 1

ZONING DISTRICT: R-60
SETBACKS REQ'D:
FRONT = 75'
SIDE = 30'
REAR = 60'
HEIGHT ALLOWED = 40'-0"
HEIGHT OF NEW ROOF = 27'-0" 7/8"

SPRINKLERED: NFPA 13D
CONCEALED HEADS TO BE USED

SCOPE OF WORK:
RESIDENTIAL ADDITION:

FIRST FLOOR ADDITION: 3,351 SF
BASEMENT ADDITION: 2,803 SF
TOTAL: 6,154 SF

BUILDING CODE: INTERNATIONAL RESIDENTIAL CODE 2015
W/ HOWARD COUNTY, MD AMENDMENTS

LEGEND

SYMBOLS	MATERIALS
<p>3 A-4 DETAIL NUMBER DRAWING LOCATION NUMBER</p> <p>A A-4 INDICATES ELEVATION (EXTERIOR/INTERIOR)</p> <p>A-A A-4 INDICATES BUILDING CROSS SECTION</p> <p>1 A-4 INDICATES WALL SECTION</p> <p>ELEVATION</p> <p>1 WALL TYPE</p> <p>A COLUMN DESIGNATION</p> <p>1 WINDOW TYPE</p> <p>10' DOOR NUMBER</p> <p>101 ROOM NUMBER</p> <p>INDICATES RATED WALL ON FLOOR PLANS</p>	<p>CMU</p> <p>EARTH</p> <p>GRAVEL</p> <p>WOOD VENEER</p> <p>CONCRETE</p> <p>STEEL</p> <p>INSULATION</p> <p>RIGID INSULATION</p> <p>FINISHED STONE</p>

GENERAL NOTES

- ALL WORK SHALL BE PERFORMED IN A PROFESSIONAL MANNER IN ACCORDANCE W/ RULES OF ACCEPTED GOOD PRACTICE.
- DIMENSIONS ARE TO WOOD FRAMING OR CONCRETE UNLESS OTHERWISE NOTED.
- ALL INSTALLATIONS SHALL BE PERFORMED IN STRICT ACCORDANCE W/ THE MATERIAL, EQUIPMENT, AND /OR MANUFACTURERS' SPECIFICATIONS.
- DIMENSIONS ARE TO BE TAKEN FROM DIMENSION STRINGS ONLY, DO NOT SCALE DRAWINGS. ANY OMISSIONS OR DISCREPANCIES ARE TO BE BROUGHT TO THE ARCHITECT'S ATTENTION IMMEDIATELY, FOR THE ARCHITECT TO RESOLVE.
- MATERIALS OR ITEMS IDENTIFIED BY A MANUFACTURER'S NAME OR TRADE NAME MAY BE SUBSTITUTED BY A LIKE PRODUCT OF A DIFFERENT MANUFACTURER, ONLY WITH PRIOR APPROVAL OF THE ARCHITECT.
- PREMISES SHALL BE LEFT "BROOM CLEAN" AND EXTERIOR SHALL BE COMPLETELY FREE OF DEBRIS UPON COMPLETION OF EACH SUB-CONTRACTOR'S WORK. ALL SUBCONTRACTORS ARE REQUIRED TO CLEAN PREMISES AND EXTERIOR OF THEIR DEBRIS DAILY. PROVIDE FINAL CONSTRUCTION "DEEP CLEAN" FOR MOVE-IN CONDITION (INCLUDING WINDOWS BY PROFESSIONAL WINDOW CLEANER). INCLUDE FULL DUCT CLEANING BY APPROVED CONTRACTOR.
- THE SUBCONTRACTOR'S ACCESS TO THE JOB SITE, STORAGE OF MATERIALS, AND PARKING SHALL BE APPROVED BY THE OWNER.
- THERE IS TO BE NO SMOKING OF ANY KIND IN RESIDENCE.
- ALL EXTERIOR WALL FRAMING TO BE 2X6 AND INTERIOR WALL FRAMING TO BE 2X4, U.N.O.
- INTERIOR HEADERS SHALL BE 2X8 LAMINATED TO MATCH WALL THICKNESS, TYPICAL U.N.O.
- FOLLOW MONTGOMERY COUNTY REQUIREMENTS FOR SPECIAL INSPECTIONS, TESTING AND REPORTING DURING CONSTRUCTION.
- NEW INTERIOR DOORS SHALL HAVE A SOLID CORE. DOOR STYLE & HARDWARE T.B.D.
- DUCTS, PIPING, ETC. SHALL BE HELD TIGHT TO FLOOR JOISTS WHENEVER POSSIBLE.

ABBREVIATIONS

AFF	ABOVE FINISHED FLOOR	MAX	MAXIMUM
ACM1	ALUMINUM COMPOSITE MATERIAL (SILVER)	MECH	MECHANICAL
ACM2	ALUMINUM COMPOSITE MATERIAL (RED)	MEZZ	MEZZANINE
ALUM	ALUMINUM	MFR	MANUFACTURER
BLDG	BUILDING	MIN	MINIMUM
BM	BEAM	MISC	MISCELLANEOUS
C/C	CENTER TO CENTER	MO	MASONRY OPENING
CJ	CONTROL JOINT	MTL	METAL
C	CENTER LINE	NIC	NOT IN CONTRACT
CLG	CEILING	NO	NUMBER
CLR	CLEAR	NTS	NOT TO SCALE
CMU	CONCRETE MASONRY UNIT	OC	ON CENTER
COL	COLUMN	OPNG	OPENING
CONC	CONCRETE	PERF	PERFORATE
CONT	CONTINUOUS	PERIM	PERIMETER
CT	CERAMIC TILE	PERP	PERPENDICULAR
CT	DEMOLITION	PL	PLATE
DET	DETAIL	P LAM	PLYWOOD
DIA	DIAMETER	PSF	POUNDS PER SQ. FT.
DIM	DIMENSION	PSI	POUNDS PER SQ. IN.
DIV	DIVISION	QTY	QUANTITY
DN	DOWN	R	RADIUS
DO	DITTO	RD	ROOF DRAIN
DWG	DRAWING	REFL	REFLECTED
EX	EXISTING	REINF	REINFORCEMENT
EA	EACH	REQ	REQUIRED
EIFS	EXT. INSULATION AND FINISHING SYSTEM	RM	ROOM
EJ	EXPANSION JOINT	RO	ROUGH OPENING
EL	ELEVATION	SCHED	SCHEDULE
ELEC	ELECTRICAL	SCW	SOLID CORE WOOD SECTION
ELEV	ELEVATOR	SECT	SECTION
ENG	ENGINEER	SF	SQUARE FOOT/FEET
EQ	EQUAL	SHT	SHEET
EXP	EXPANSION	SIM	SIMILAR
EXT	EXTERIOR	SPECS	SPECIFICATION(S)
FD	FLOOR DRAIN	SQ	SQUARE
FDN	FOUNDATION	SS	STAINLESS STEEL
FE	FIRE EXTINGUISHER	STD	STANDARD
FF	FINISHED FLOOR	STL	STEEL
FIN	FINISH or FINISHED	STOR	STORAGE
F	FLOOR	STRUCT	STRUCTURAL
FLOUR	FLOURESCENT	SY	SYMMETRICAL
FT	FOOT or FEET	TBD	TO BE DETERMINED
FTG	FOOTING	T&B	TONGUE AND BOTTOM
GA	GAGE	T&G	TONGUE AND GROOVE
GALV	GALVANIZED	TEL	TELEPHONE
GC	GENERAL CONTRACTOR	TEMP	TEMPORARY
GL	GLASS or GLAZING	THK	THICK
GYP BD	GYP SUM BOARD	THRU	THROUGH
HC	HOLLOW CORE	TYP	TYPICAL
HM	HOLLOW METAL	UNO	UNLESS NOTED OTHERWISE
HORIZ	HORIZONTAL	VB	VINYL BASE
HT	HEIGHT	VCT	VINYL COMPOSITE TILE
HVAC	HEATING, VENTILATION, AIR CONDITIONING	VERT	VERTICAL
IN	INCH	VIF	VERIFY IN FIELD
INFC	INFORMATION	W/	WIDTH
INSUL	INSULATION	WD	WOOD
INT	INTERIOR	W/O	WITHOUT
JT	JOINT	WWF	WELDED WIRE FABRIC
LAM	LAMINATE		
MAS	MASONRY		

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HOA LETTER

October 28, 2020

Sherman and Debra Canapp
6501 Heather Glen Way
Clarksville, Md. 21029

RE: Garage / House Addition

Sherman, Debra
Upon review of your schematic drawings submitted to us, Willow Pond Community Association, we APPROVE your plans. The plans and site plans would additionally be required to meet all county codes.

Sincerely,
Rick Minor
Greenfield Homes
Willow Pond Community Association

DRAWING LIST

- COVER**
- A0.1 COVER SHEET
A0.2 PROJECT DATA
A0.3 SCHEDULES
- ARCHITECTURAL**
- A1.0 BASEMENT FLOOR PLAN
A1.1 FIRST FLOOR PLAN
A1.2 ROOF PLAN
- A2.0 WEST ELEVATION
A2.1 SOUTH ELEVATION
A2.2 EAST ELEVATION
A2.3 NORTH ELEVATION
- A3.0 BUILDING SECTION
A3.1 DETAILS
- E1.0 BASEMENT POWER & DATA PLAN
E1.1 FIRST FLOOR POWER & DATA PLAN
- E2.0 BASEMENT REFLECTED CEILING PLAN
E2.1 FIRST FLOOR REFLECTED CEILING PLAN
- STRUCTURAL**
- S1.0 FOUNDATION PLAN
S1.1 FIRST FLOOR FRAMING PLAN
S1.2 ROOF FRAMING PLAN
S1.3 OVERBUILD PLAN
- S2.0 BASEMENT WALL BRACING PLAN
S2.1 FIRST FLOOR WALL BRACING PLAN

VICINITY MAP



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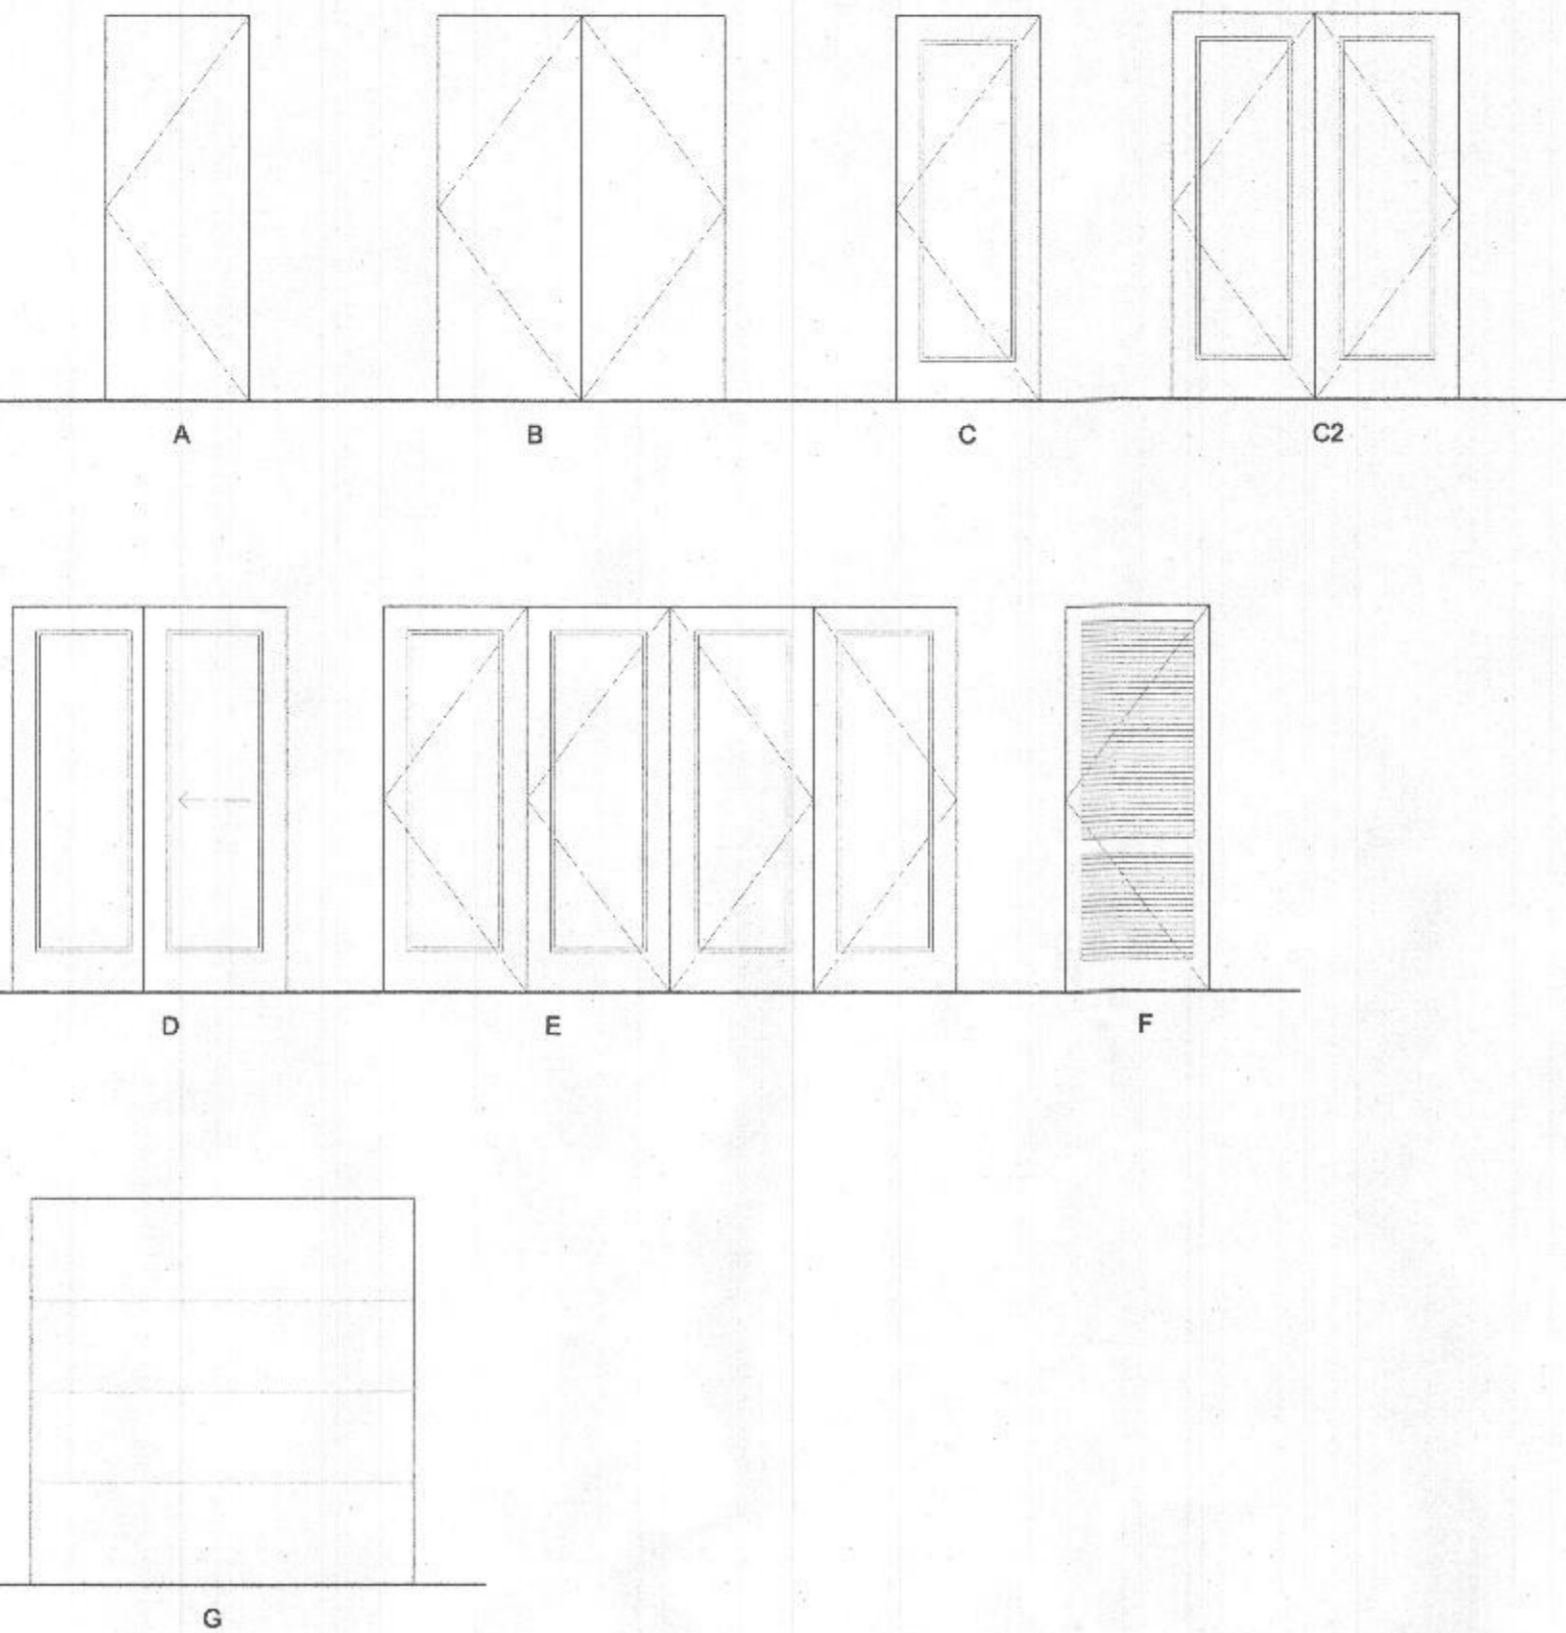
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A0.2
Sheet Title
PROJECT DATA

Project Number: CAN001a
File Name: CAN001aE01.dwg

DOOR SCHEDULE

NO.	MANUFACTURER	SIZE	DOOR/FRAME TYPE	THICK	MAT.	FIN.	HARDWARE	REMARKS
BASEMENT								
001a	ANDERSEN	3'-0"x8'-0"	A	1 3/4"	WD./GLASS	PTD.	H02	WEATHER SEAL
001b	---	12'-0"x8'-0"	G	--	--	PTD.	--	TO MATCH EXISTING
001c	---	3'-0"x3'-0"	A	1 3/4"	WD./GLASS	PTD.	H02	WEATHER SEAL, 18" SIDELITE
002	---	(2) 3'-0"x8'-0"	B	1 3/8"	WD.	PTD.	H03	
003	---	14'-0"x8'-0"	B	1 3/4"	WD./GLASS	PTD.	H02	
FIRST FLOOR								
001a	ANDERSEN	3'-0"x8'-0"	A	1 3/4"	WD./GLASS	PTD.	H02	WEATHER SEAL
001b	ANDERSEN	3'-0"x8'-0"	A	1 3/4"	WD./GLASS	PTD.	H02	WEATHER SEAL
001c	ANDERSEN	3'-0"x8'-0"	A	1 3/4"	WD./GLASS	PTD.	H02	WEATHER SEAL
102	---	(2) 2'-0"x8'-0"	C1	1 3/8"	WD.	PTD.	H03	
103a	---	9'-0"x11'-0"	G	--	--	PTD.	--	TO MATCH EXISTING
103b	---	8'-0"x8'-0"	G	--	--	PTD.	--	TO MATCH EXISTING
103c	ANDERSEN	2'-8"x6'-0"	C1	1 3/4"	WD./GLASS	PTD.	H02	WEATHER SEAL
104	ANDERSEN	6'-0"x8'-0"	C1	1 3/4"	WD./GLASS	PTD.	H02	WEATHER SEAL
105	ANDERSEN	2'-8"x8'-0"	C1	1 3/4"	WD./GLASS	PTD.	H03	WEATHER SEAL, CLOSER
106	---	2'-6"x6'-0"	C1	1 3/8"	WD.	PTD.	H04	
107	---	2'-8"x8'-0"	A	1 3/8"	WD.	PTD.	H03	
108a	---	(2) 3'-0"x8'-0"	A	1 3/8"	WD.	PTD.	H03	
108b	---	2'-6"x8'-0"	A	1 3/8"	WD.	PTD.	H03	
109	---	(2) 2'-6"x8'-0"	B	1 3/8"	WD.	PTD.	H05	
110	---	2'-6"x6'-0"	A	1 3/8"	WD.	PTD.	H03	
111	---	2'-6"x8'-0"	A	1 3/8"	WD.	PTD.	H04	
112	---	2'-6"x8'-0"	A	1 3/8"	WD.	PTD.	H04	
113	---	2'-6"x8'-0"	A	1 3/8"	WD.	PTD.	H04	

DOOR TYPES



WINDOW SCHEDULE

NO.	MANUFACTURER	TYPE	CATALOG NO.	ROUGH OPENING	REMARKS	QUANTITY
1	JELD-WEN	FIXED	CS-3030	3'-0 3/4"x3'-0 3/4"		2
2	JELD-WEN	FIXED	CS-2626	2'-6 3/4"x2'-6 3/4"		3
3	JELD-WEN	CASEMENT	CS-2646	2'-6"x4'-6 3/4"		4
4	JELD-WEN	CASEMENT	CS-2646-2	5'-0 3/4"x4'-6 3/4"		5
5	JELD-WEN	CASEMENT	CS-2666-3	7'-6 3/4"x6'-6 3/4"		4
6	JELD-WEN	FIXED	CS-2646	2'-6 3/4"x4'-6 3/4"		2
7	JELD-WEN	CASEMENT	CS-2646-3	7'-6 3/4"x4'-6 3/4"		2
8	JELD-WEN	CASEMENT	CS-2670	2'-6 3/4"x7'-0 3/4"		5
9	JELD-WEN	CASEMENT	CS-2666	2'-6 3/4"x5'-6 3/4"		2
10	JELD-WEN	CASEMENT	CS-2666	2'-6 3/4"x6'-6 3/4"		2

GENERAL WINDOW NOTES:

1. PROVIDE SCREENS FOR ALL OPERABLE WINDOWS (SCREEN FRAME COLOR TO MATCH EXISTING)
2. ALL WINDOWS TO BE PR-PRIMED.
3. CONFIRM HARDWARE FINISH WITH ARCHITECT AND OWNER PRIOR TO ORDER.
4. ALL GLAZING TO BE DOUBLE PANELED, LOW E, CLEAR INSULATED.
5. CONFIRM OVERALL WINDOW SCHEDULE WITH ARCHITECT PRIOR TO ORDER.
6. ALL WINDOWS AND GLASS DOORS DIVISIONS TO MATCH EXISTING.
7. WHITE JAMB LINERS.
8. PROVIDE EGRESS HARDWARE IN EGRESS WINDOWS AS REQUIRED.
9. SEE ELEVATIONS FOR TYPICAL HEAD HEIGHTS ABOVE FINISHED SUBFLOOR.
10. SEE ELEVATION FOR GRILLE PATTERNS.

HARDWARE SCHEDULE

SET	MANUFACTURER	FUNCTION	PRODUCT NO.	FIN.
H01	EMTEK	KEYED LOCKSET W/ DEADBOLT		TBD
H02	EMTEK	KEYED LOCKSET		TBD
H03	EMTEK	PASSAGE SET		TBD
H04	EMTEK	PRIVACY SET		TBD
H05	EMTEK	DUMMY SET		TBD
H06	EMTEK	BARN DOOR SET		TBD

HARDWARE NOTES

ALL HINGES TO MATCH DOOR HARDWARE FINISH.



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Checked By:		R. P.
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Plot Date:		


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Sheet Title

Schedules

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Renovation/Addition
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Clarksville, MD 21029





1 BASEMENT FLOOR PLAN
Scale: 1/4" = 1'-0"

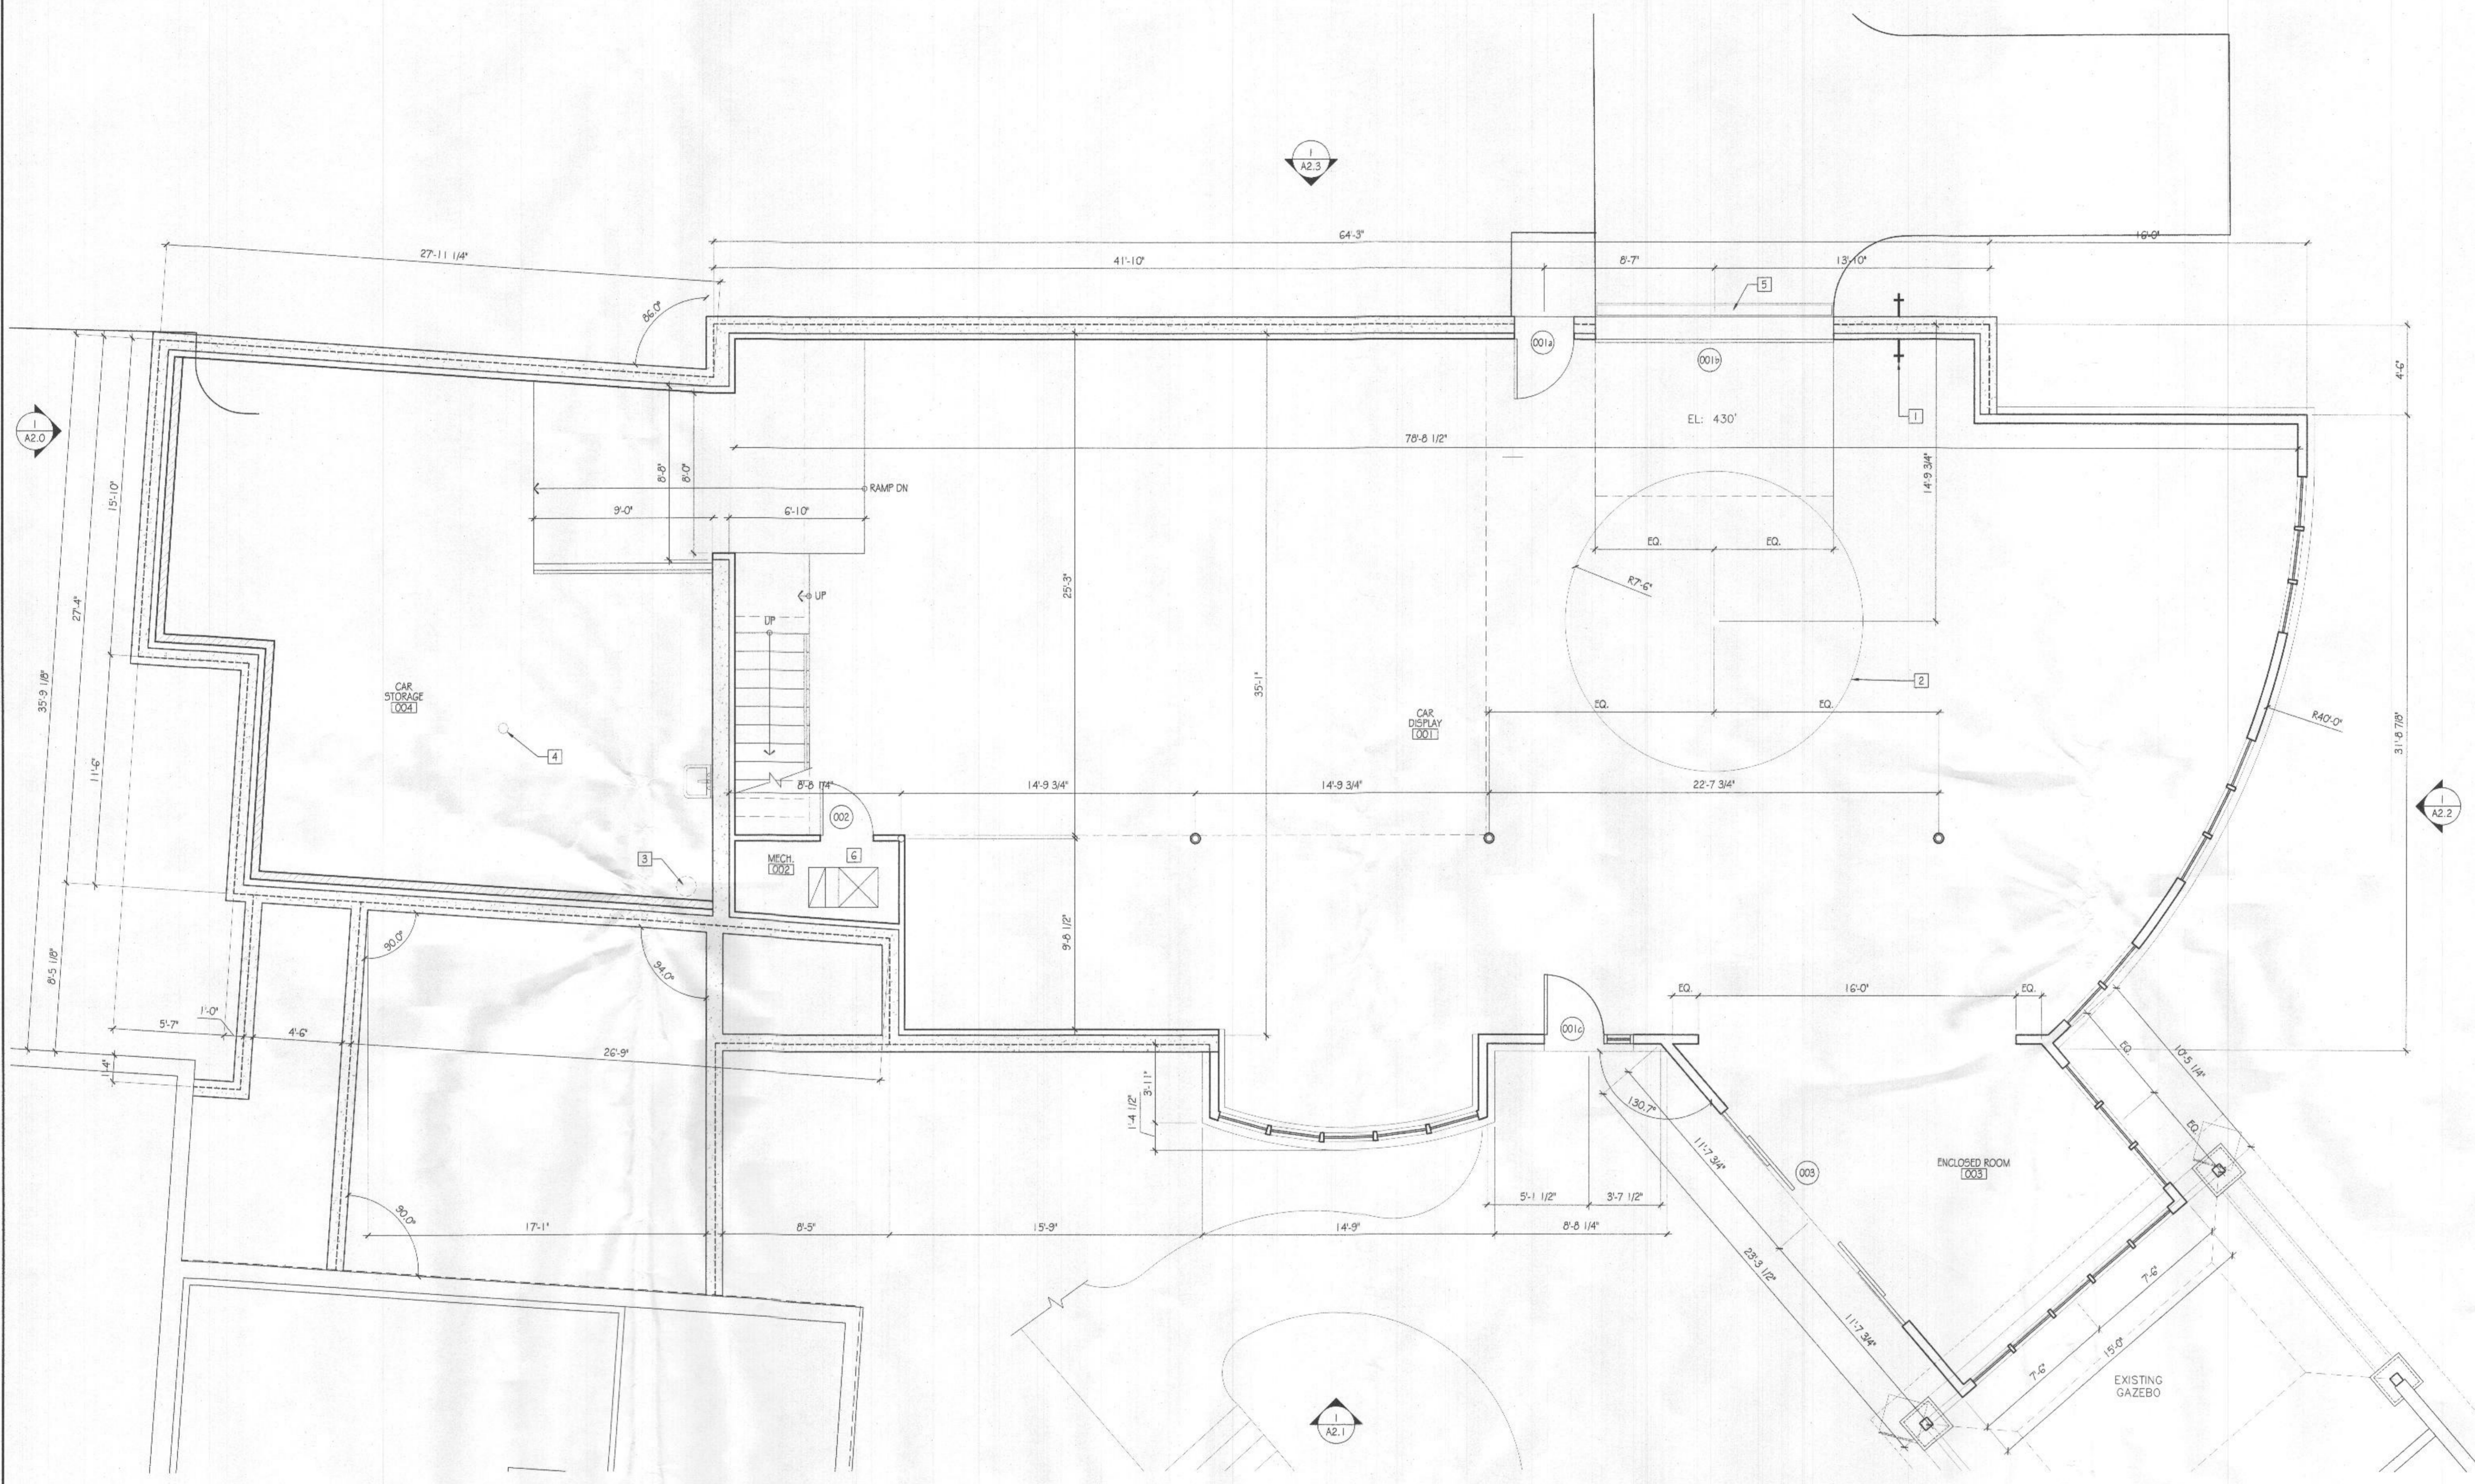KEYED PLAN NOTES
1. PROVIDE MIXING VALVE ON INTERIOR HOSE BIB.
2. PROVIDE CARTURNER TURN TABLE. SEE MANUFACTURERS INSTRUCTIONS FOR INSTALLATION.
3. SUMP PUMP & CROCK.
4. FLOOR DRAIN.
5. TRENCH DRAIN.
6. COORDINATE ELECTRICAL PANEL LOCATION TO TIE INTO EXISTING POWER.

GENERAL NOTES
1. ALL EXTERIOR WALLS SHALL BE 2X6 STUDS @ 16" O.C. U.N.O.
2. ALL INTERIOR WALLS SHALL BE 2X4 STUDS @ 16" O.C. U.N.O.
3. ALL INTERIOR WALLS W/ CASING OPENINGS SHALL BE 2X6 STUDS U.N.O.
4. PROVIDE REBAR INTO GROUND FOR LIGHTNING PROTECTION.

PLAN LEGEND			
	NEW DOOR # TAG - SEE DOOR SCHEDULE		EXISTING DOOR TO REMAIN
	NEW PARTITION - TYPE I U.N.O.		EXISTING DOOR TO BE DEMOUSHED
	AREA NOT IN CONTRACT - NO WORK PROPOSED		EXISTING WALL/PARTITION TO REMAIN
			EXISTING WALL/PARTITION TO BE DEMOUSHED

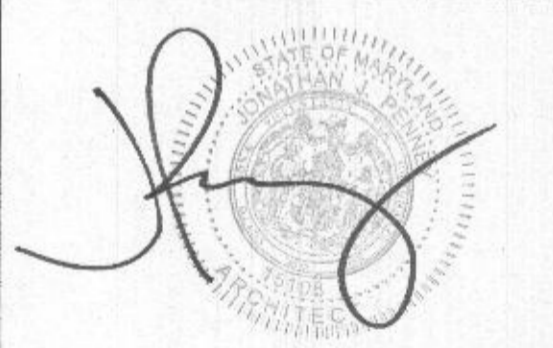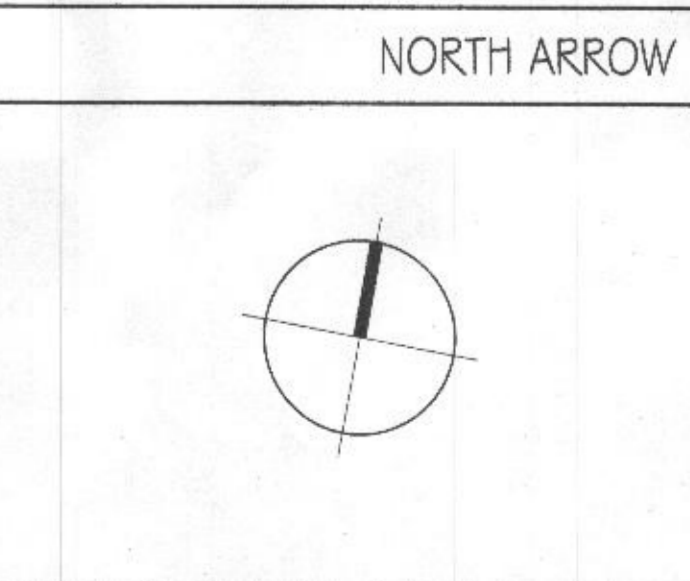

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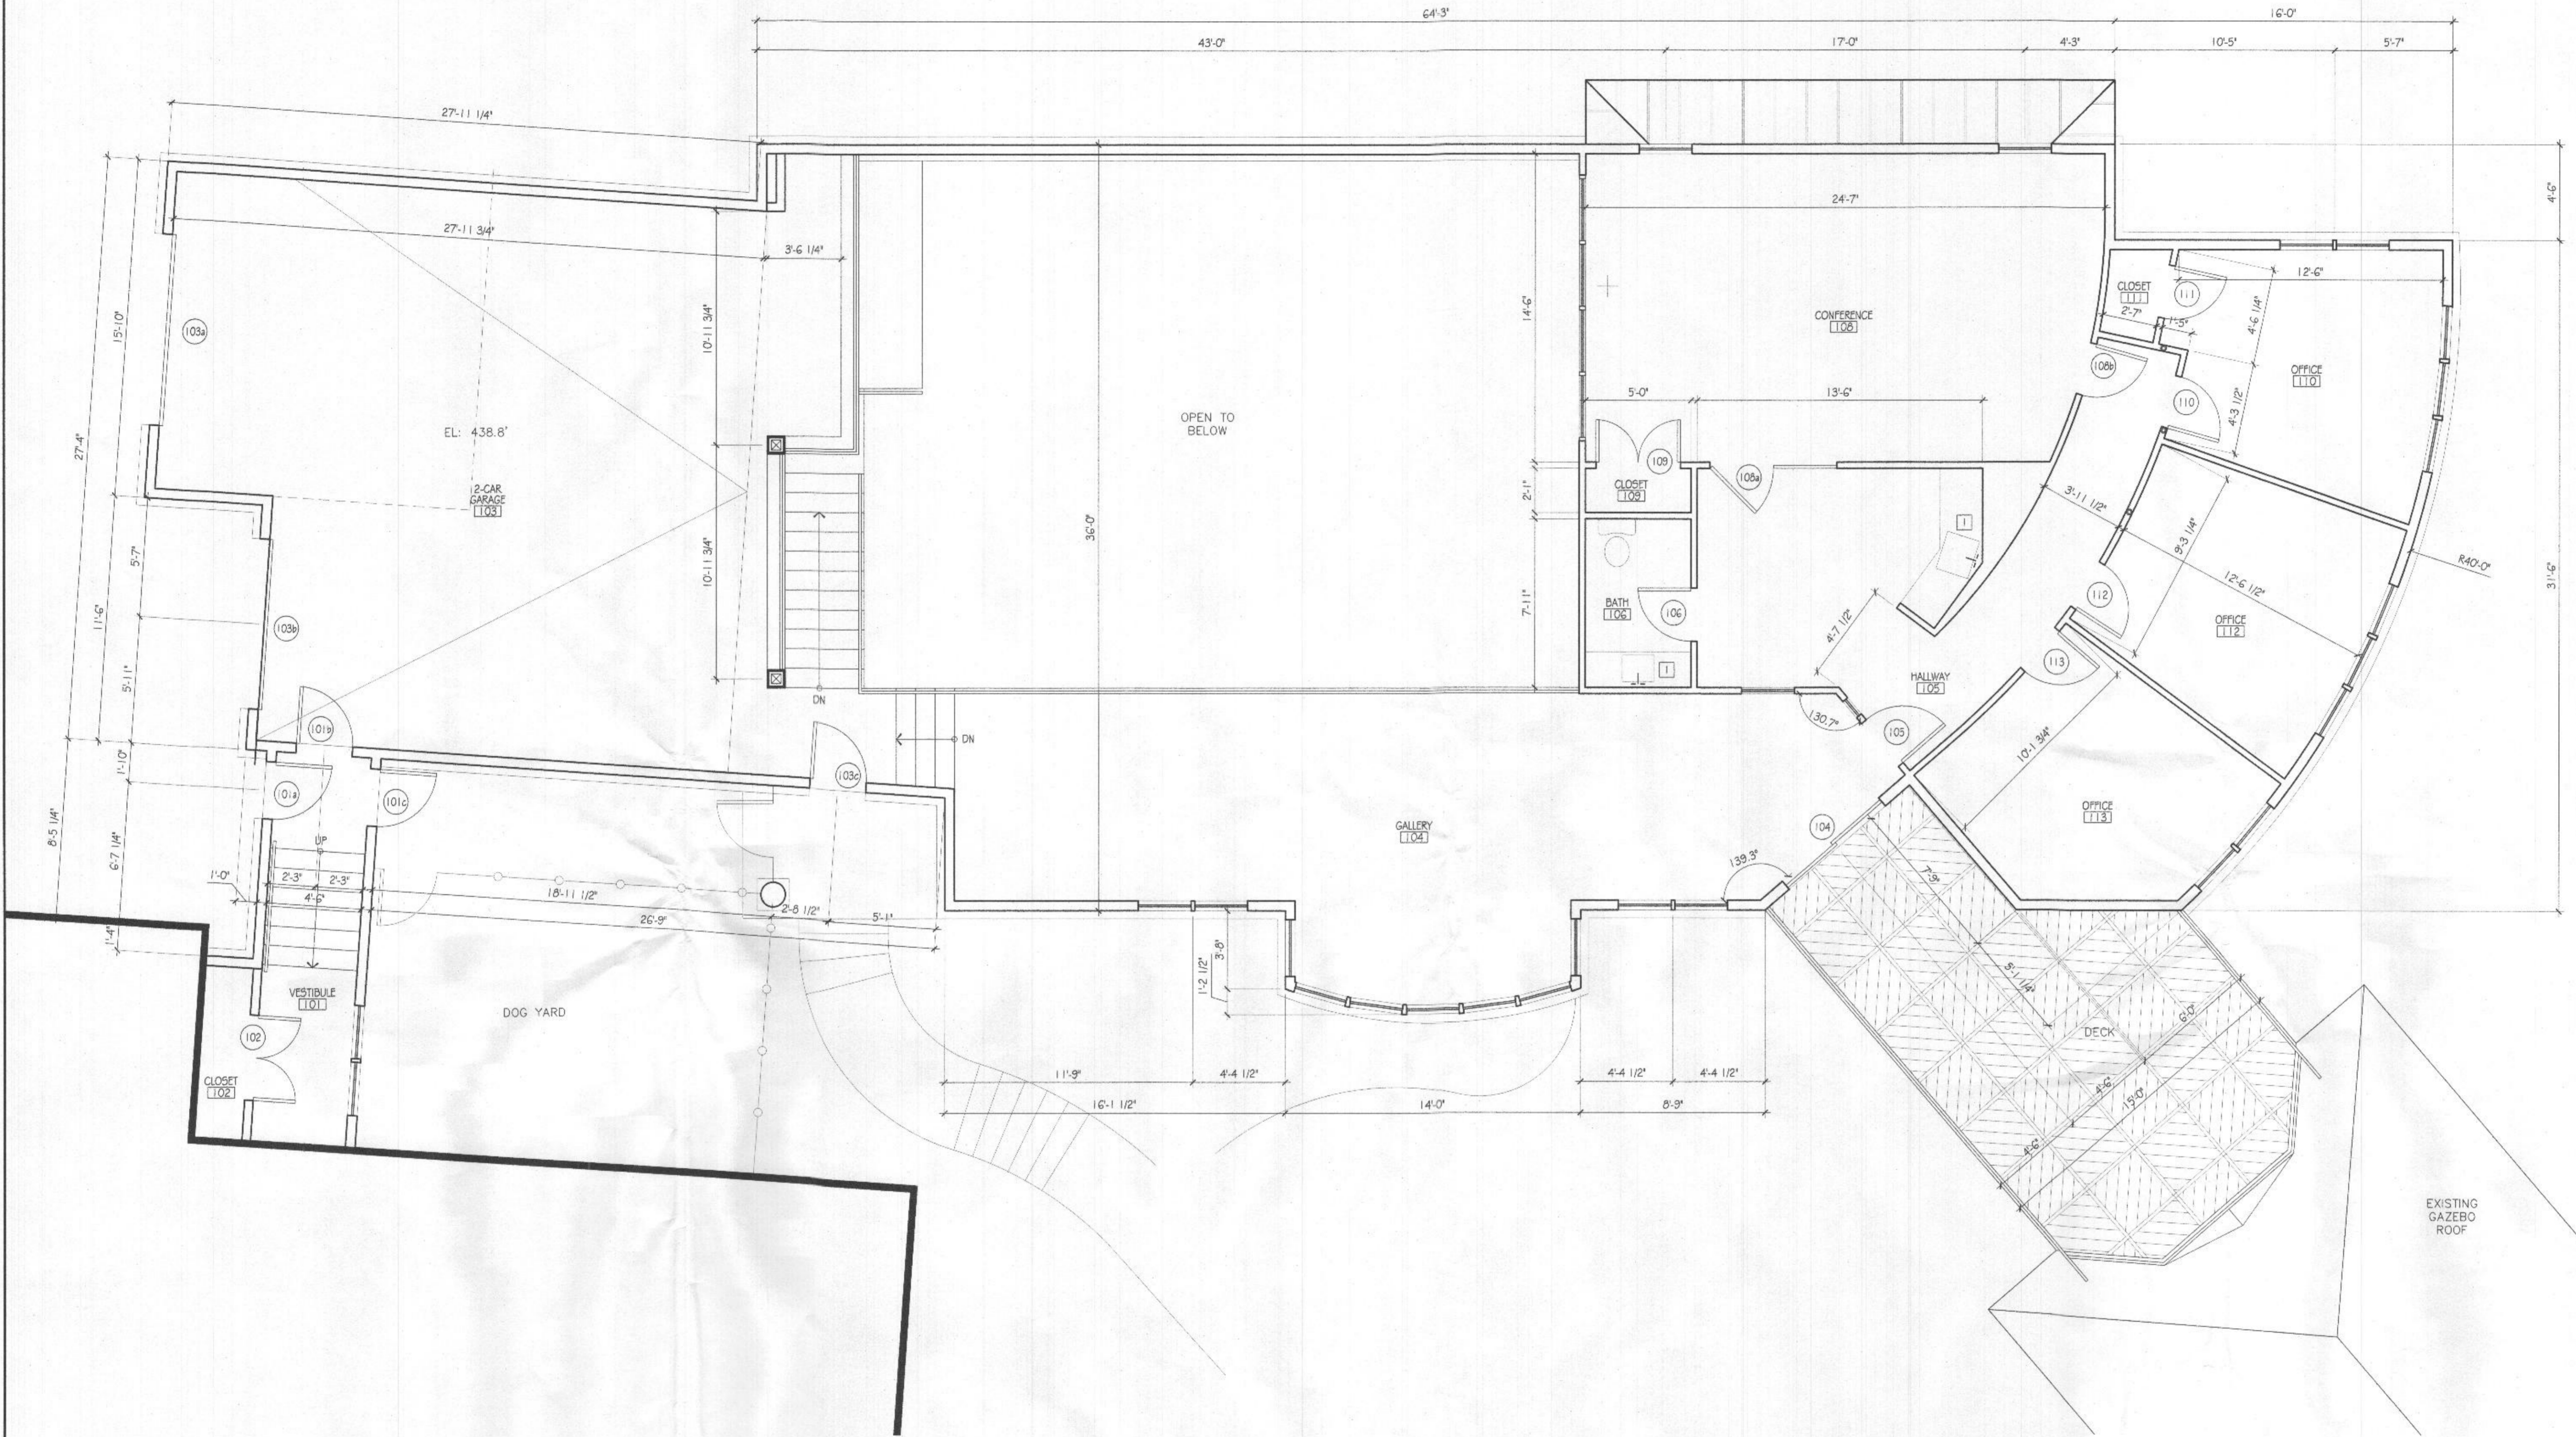
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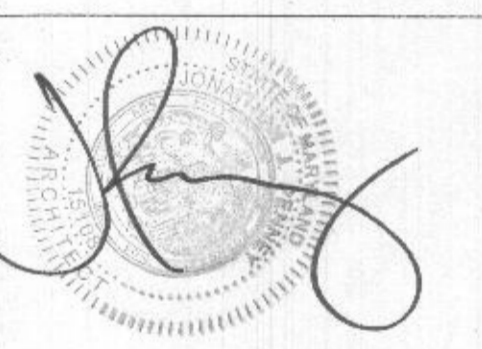
Project Number	File Name
CAN001a	CAN001aF01.dwg

Sheet Number
A1.0
Sheet Title
Basement Floor Plan

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1 FIRST FLOOR PLAN
Scale: 1/4" = 1'-0"



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Drawn By: M.B.
Checked By: R.P.
Checked By:
Plot Date:

KEYED PLAN NOTES

- TANKLESS WATER HEATER.


GENERAL NOTES

- ALL EXTERIOR WALLS SHALL BE 2X6 STUDS @ 16" O.C. U.N.O.
- ALL INTERIOR WALLS SHALL BE 2X4 STUDS @ 16" O.C. U.N.O.
- ALL INTERIOR WALLS W/ CAVED OPENINGS SHALL BE 2X6 STUDS U.N.O.

PLAN LEGEND


	NEW DOOR # TAG - SEE DOOR SCHEDULE		EXISTING DOOR TO REMAIN
	NEW PARTITION - TYPE 1 U.N.O.		EXISTING DOOR TO BE DEMOLISHED
	AREA NOT IN CONTRACT - NO WORK PROPOSED		EXISTING WALL/PARTITION TO REMAIN
			EXISTING WALL/PARTITION TO BE DEMOLISHED

NORTH ARROW

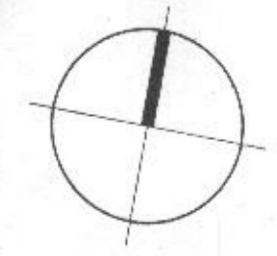

Sheet Number
A1.1
Sheet Title
First Floor Plan

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1 ROOF PLAN Scale: 1/4" = 1'-0"

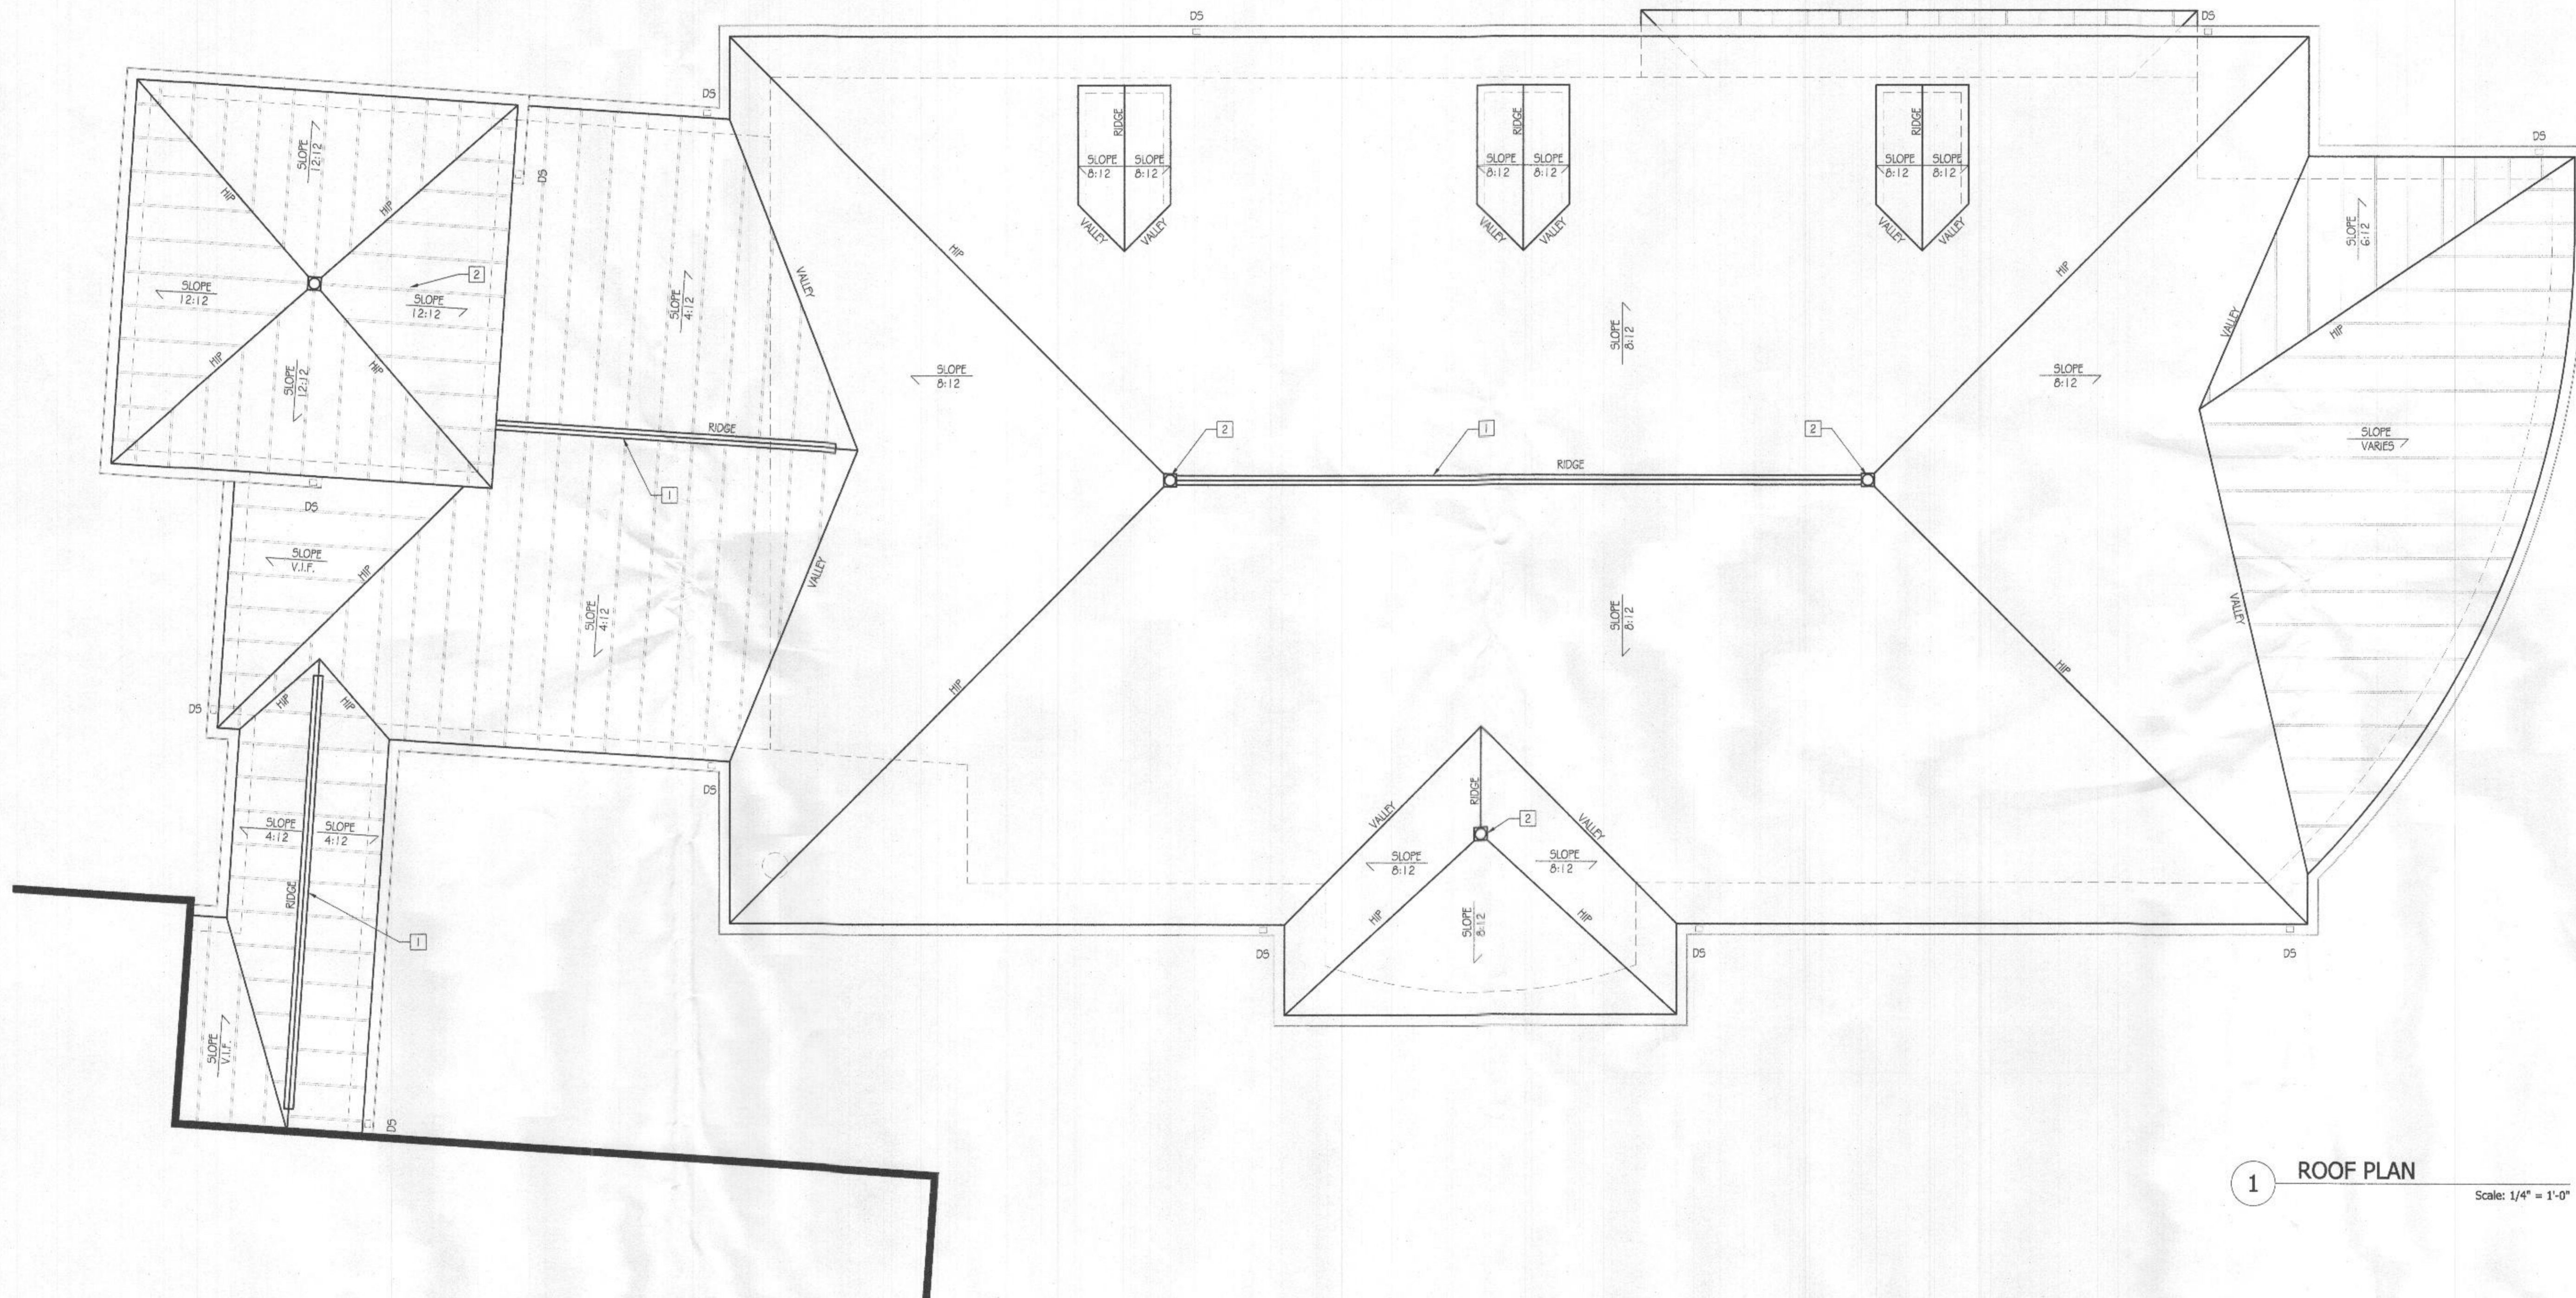

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	Checked By:	R.P.
	Checked By:	
	Plot Date:	

KEYED PLAN NOTES

1. RIDGE VENT.
2. FINAL, TO MATCH EXISTING.


GENERAL NOTES

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2. ALL INTERIOR WALLS SHALL BE 2X4 STUDS @ 16" O.C. U.N.O.
3. ALL INTERIOR WALLS W/ CASHE OPENINGS SHALL BE 2X6 STUDS U.N.O.

PLAN LEGEND

	NEW DOOR # TAG - SEE DOOR SCHEDULE		EXISTING DOOR TO REMAIN
	NEW PARTITION - TYPE 1 U.N.O.		EXISTING DOOR TO BE DEMOLISHED
	AREA NOT IN CONTRACT - NO WORK PROPOSED		EXISTING WALL/PARTITION TO REMAIN
			EXISTING WALL/PARTITION TO BE DEMOLISHED

NORTH ARROW

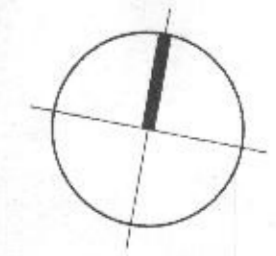

Sheet Number

A1.2

Sheet Title

Roof Plan

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1 WEST ELEVATION
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Drawn By: M.B.
Checked By: R.P.
Checked By:
Plot Date:

KEYED PLAN NOTES

GENERAL NOTES

1. NOT USED.

- ALL EXTERIOR WALLS SHALL BE 2X6 STUDS @ 12" O.C. U.N.O.
- ALL INTERIOR WALLS SHALL BE 2X4 STUDS @ 16" O.C. U.N.O.
- ALL INTERIOR WALLS W/ CASED OPENINGS SHALL BE 2X6 STUDS U.N.O.

Sheet Number
A2.0
Sheet Title
West Elevation
Project Number
CAN001a
File Name
CAN001aE01.dwg

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Clarksville, MD 21029



1 SOUTH ELEVATION
Scale: 1/4" = 1'-0"



I certify that these documents were prepared or approved by me, and that I am a duly licensed architect under the laws of the State of Maryland, license number: 13108, expiration date: July 31, 2021.

ISSUED FOR PERMIT	01.21.21
ISSUED FOR PERMIT	12.29.20
ISSUED FOR REVIEW	12.21.20
ISSUED FOR REVIEW	12.07.20
ISSUED FOR REVIEW	11.17.20

No.	Issue / Revision	Date
Drawn By:		M.B.
Checked By:		R. P.
Checked By:		
Plot Date:		

KEYED PLAN NOTES

- NOT USED.

GENERAL NOTES

- ALL EXTERIOR WALLS SHALL BE 2X6 STUDS @ 16" O.C. U.N.O.
- ALL INTERIOR WALLS SHALL BE 2X4 STUDS @ 16" O.C. U.N.O.
- ALL INTERIOR WALLS W/ CASSED OPENINGS SHALL BE 2X6 STUDS U.N.O.

Sheet Number
A2.1
Sheet Title
South Elevation

Canapp Residence
Renovation/Addition
6501 Heather Glen Way
Clarksville, MD 21029



1 EAST ELEVATION
Scale: 1/4" = 1'-0"



I certify that these documents were prepared or approved by me, and that I am a duly licensed architect under the laws of the State of Maryland. License number: 15508, expiration date: July 31, 2021.

No.	Issue / Revision	Date
	ISSUED FOR PERMIT	01.21.21
	ISSUED FOR PERMIT	12.29.20
	ISSUED FOR REVIEW	12.21.20
	ISSUED FOR REVIEW	12.07.20
	ISSUED FOR REVIEW	11.17.20

Drawn By: M.B.
Checked By: R. P.
Plot Date:

KEYED PLAN NOTES


1. NOT USED.

GENERAL NOTES

- ALL EXTERIOR WALLS SHALL BE 2X6 STUDS @ 16" O.C. U.N.O.
- ALL INTERIOR WALLS SHALL BE 2X4 STUDS @ 16" O.C. U.N.O.
- ALL INTERIOR WALLS W/ CASING OPENINGS SHALL BE 2X6 STUDS U.N.O.

Sheet Number
A2.2
Sheet Title
East Elevation

Canapp Residence
Renovation/Addition
6501 Heather Glen Way
Clarksville, MD 21029

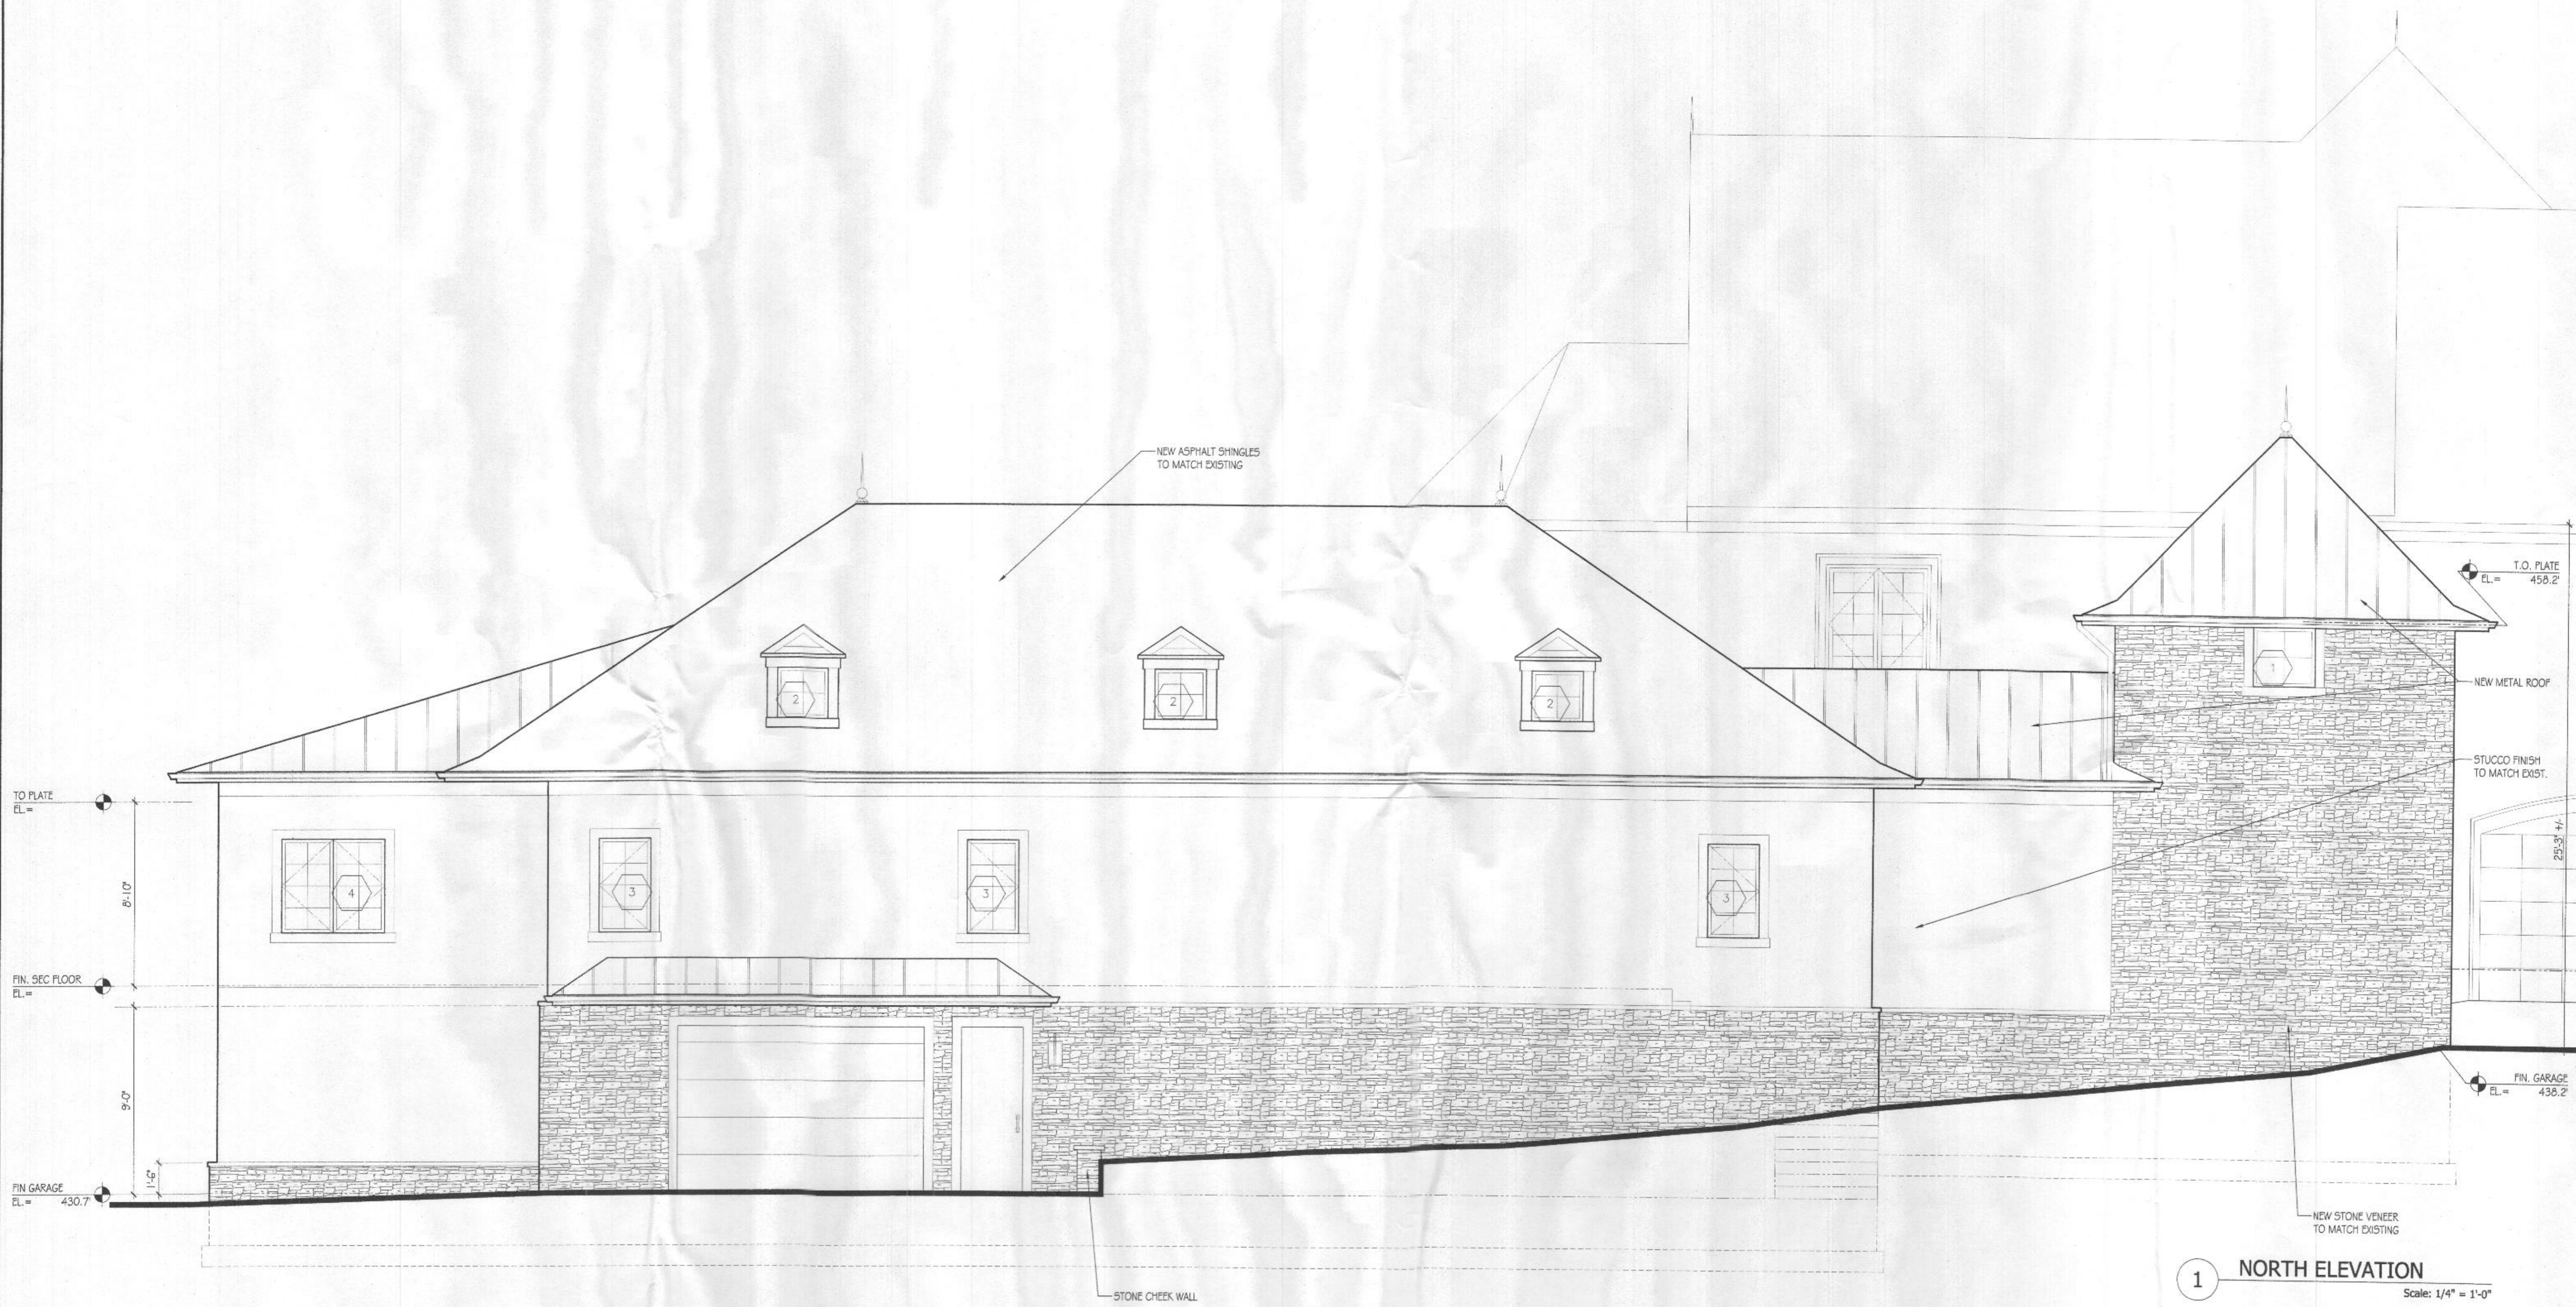

1 NORTH ELEVATION
Scale: 1/4" = 1'-0"



I certify that these documents were prepared or approved by me, and that I am a duly licensed architect under the laws of the State of Maryland, license number: 13308, expiration date: July 31, 2021.

REISSUED FOR PERMIT	01.21.21
ISSUED FOR PERMIT	12.29.20
ISSUED FOR REVIEW	12.21.20
ISSUED FOR REVIEW	12.07.20
ISSUED FOR REVIEW	11.17.20

No.	Issue / Revision	Date
Drawn By:		M.B.
Checked By:		R. P.
Checked By:		
Plot Date:		

KEYED PLAN NOTES

- 1. NOT USED.

GENERAL NOTES

- ALL EXTERIOR WALLS SHALL BE 2X6 STUDS @ 16" O.C. U.N.O.
- ALL INTERIOR WALLS SHALL BE 2X4 STUDS @ 16" O.C. U.N.O.
- ALL INTERIOR WALLS W/ CASING OPENINGS SHALL BE 2X6 STUDS U.N.O.

Sheet Number
A2.3
Sheet Title
North Elevation
Project Number
CAN001a
File Name
CAN001aE01.dwg