



Building Permit Application

Howard County Maryland
Department of Inspection Licenses and Permits
3430 Court House Drive
Permits: 410-313-2455
www.howardcountymd.gov

Date Received: _____

Permit No.: B15005307

Building Address: 11021 FURZY Hollow Way
 City: Marriottsville State: MD Zip Code: 21104
 Suite/Apt. # _____ SDP/WP/BA #: 13-074
 Census Tract: _____ Subdivision: Melvin Park
 Section: _____ Area: _____ Lot: 2
 Tax Map: 10 Parcel: 144 Grid: 13
 Zoning: R2-80 Map Coordinates: _____ Lot Size: 3.08

Existing Use: Vacant Lot
 Proposed Use: Single Family Home
 Estimated Construction Cost: \$ 225,000
 Description of Work: Rebuild w/ concrete, main, 2 car garage, 2 story, full bsmt, 14x12 3/4, 1 1/2 bath, 2 car garage (6 BR)
 Occupant or Tenant: _____
 Was tenant space previously occupied? Yes No
 Contact Name: _____
 Address: _____
 City: _____ State: _____ Zip Code: _____
 Phone: _____ Fax: _____
 Email: _____

Property Owner's Name: Withansburg Group LLC
 Address: 5185 Howard's Mill Rd #200
 City: Columbia State: MD Zip Code: 21046
 Phone: 410-997-5800 Fax: _____
 Email: marc@withansburg.com

Applicant's Name & Mailing Address, (if other than stated herein)
 Applicant's Name: _____
 Address: _____
 City: _____ State: _____ Zip Code: _____
 Phone: _____ Fax: _____
 Email: _____

Contractor Company: _____
 Contact Person: _____
 Address: _____
 City: _____ State: _____ Zip Code: _____
 License No.: 155
 Phone: _____ Fax: _____
 Email: _____

Engineer/Architect Company: _____
 Responsible Design Prof.: _____
 Address: _____
 City: _____ State: _____ Zip Code: _____
 Phone: _____ Fax: _____
 Email: _____

| Commercial Building Characteristics | Residential Building Characteristics | |
|--|--|-------|
| Height: | <input type="checkbox"/> SF Dwelling <input type="checkbox"/> SF Townhouse | |
| No. of stories: | Depth | Width |
| Gross area, sq. ft./floor: | 1 st floor: | |
| | 2 nd floor: | |
| Area of construction (sq. ft.): | Basement: | |
| | <input type="checkbox"/> Finished Basement | |
| Use group: | <input checked="" type="checkbox"/> Unfinished Basement | |
| | <input type="checkbox"/> Crawl Space | |
| Construction type: | <input type="checkbox"/> Slab on Grade | |
| <input type="checkbox"/> Reinforced Concrete | No. of Bedrooms: | |
| <input type="checkbox"/> Structural Steel | Multi-family Dwelling | |
| <input type="checkbox"/> Masonry | No. of efficiency units: | |
| <input type="checkbox"/> Wood Frame | No. of 1 BR units: | |
| <input type="checkbox"/> State Certified Modular | No. of 2 BR units: | |
| | No. of 3 BR units: | |
| | Other Structure: | |
| | Dimensions: | |
| > Roadside Tree Project Permit | Footings: | |
| <input type="checkbox"/> Yes <input type="checkbox"/> No | Roof: | |
| Roadside Tree Project Permit # | <input type="checkbox"/> State Certified Modular | |
| | <input type="checkbox"/> Manufactured Home | |

| Utilities | |
|---|--|
| Water Supply | |
| <input type="checkbox"/> Public | |
| <input type="checkbox"/> Private | |
| Sewage Disposal | |
| <input type="checkbox"/> Public | |
| <input checked="" type="checkbox"/> Private | |
| Electric: <input type="checkbox"/> Yes <input type="checkbox"/> No | |
| Gas: <input type="checkbox"/> Yes <input type="checkbox"/> No | |
| Heating System | |
| <input type="checkbox"/> Electric <input type="checkbox"/> Oil | |
| <input type="checkbox"/> Natural Gas <input type="checkbox"/> Propane Gas | |
| <input type="checkbox"/> Other: | |
| Sprinkler System: | |
| <input type="checkbox"/> Yes <input type="checkbox"/> No | |
| Grading Permit Number: | |
| Building Shell Permit Number: | |

THE UNDERSIGNED HEREBY CERTIFIES AND AGREES AS FOLLOWS: (1) THAT HE/SHE IS AUTHORIZED TO MAKE THIS APPLICATION; (2) THAT THE INFORMATION IS CORRECT; (3) THAT HE/SHE WILL COMPLY WITH ALL REGULATIONS OF HOWARD COUNTY WHICH ARE APPLICABLE THERETO; (4) THAT HE/SHE WILL PERFORM NO WORK ON THE ABOVE REFERENCED PROPERTY NOT SPECIFICALLY DESCRIBED IN THIS APPLICATION; (5) THAT HE/SHE GRANTS COUNTY OFFICIALS THE RIGHT TO ENTER ONTO THIS PROPERTY FOR THE PURPOSE OF INSPECTING THE WORK PERMITTED AND POSTING NOTICES.

Applicant's Signature: Marcus Withansburg Print Name: Marcus Withansburg
 Email Address: marc@withansburg.com Date: 12/4/15
 Title/Company: Withansburg Group LLC


Checks Payable to: DIRECTOR OF FINANCE OF HOWARD COUNTY
 PLEASE WRITE NEATLY & LEGIBLY
 -FOR OFFICE USE ONLY-

| AGENCY | DATE | SIGNATURE OF APPROVAL |
|----------------------|-----------------|-----------------------|
| State Highways | | |
| Building Officials | | |
| PSZA (Zoning) | | |
| PSZA (Engineering) | | |
| Health | <u>12-24-15</u> | <u>Bernard</u> |

Is Sediment Control approval required for issuance? Yes No
 CONTINGENCY CONSTRUCTION START

| DPZ SETBACK INFORMATION |
|---|
| Front: |
| Rear: |
| Side: |
| Side St.: |
| All minimum setbacks met? <input type="checkbox"/> Yes <input type="checkbox"/> No |
| Is Entrance Permit Required? <input type="checkbox"/> Yes <input type="checkbox"/> No |
| Historic District? <input type="checkbox"/> Yes <input type="checkbox"/> No |
| Lot Coverage for New Town Zone: |
| SDP/Red-line approval date: |

| | | |
|----------------|----|--|
| Filing Fee | \$ | |
| Permit Fee | \$ | |
| Tech Fee | \$ | |
| Excise Tax | \$ | |
| Guaranty Fund | \$ | |
| Add'l per Fee | \$ | |
| Total Fees | \$ | |
| Sub-Total Paid | \$ | |
| Balance Due | \$ | |
| Check # | # | |

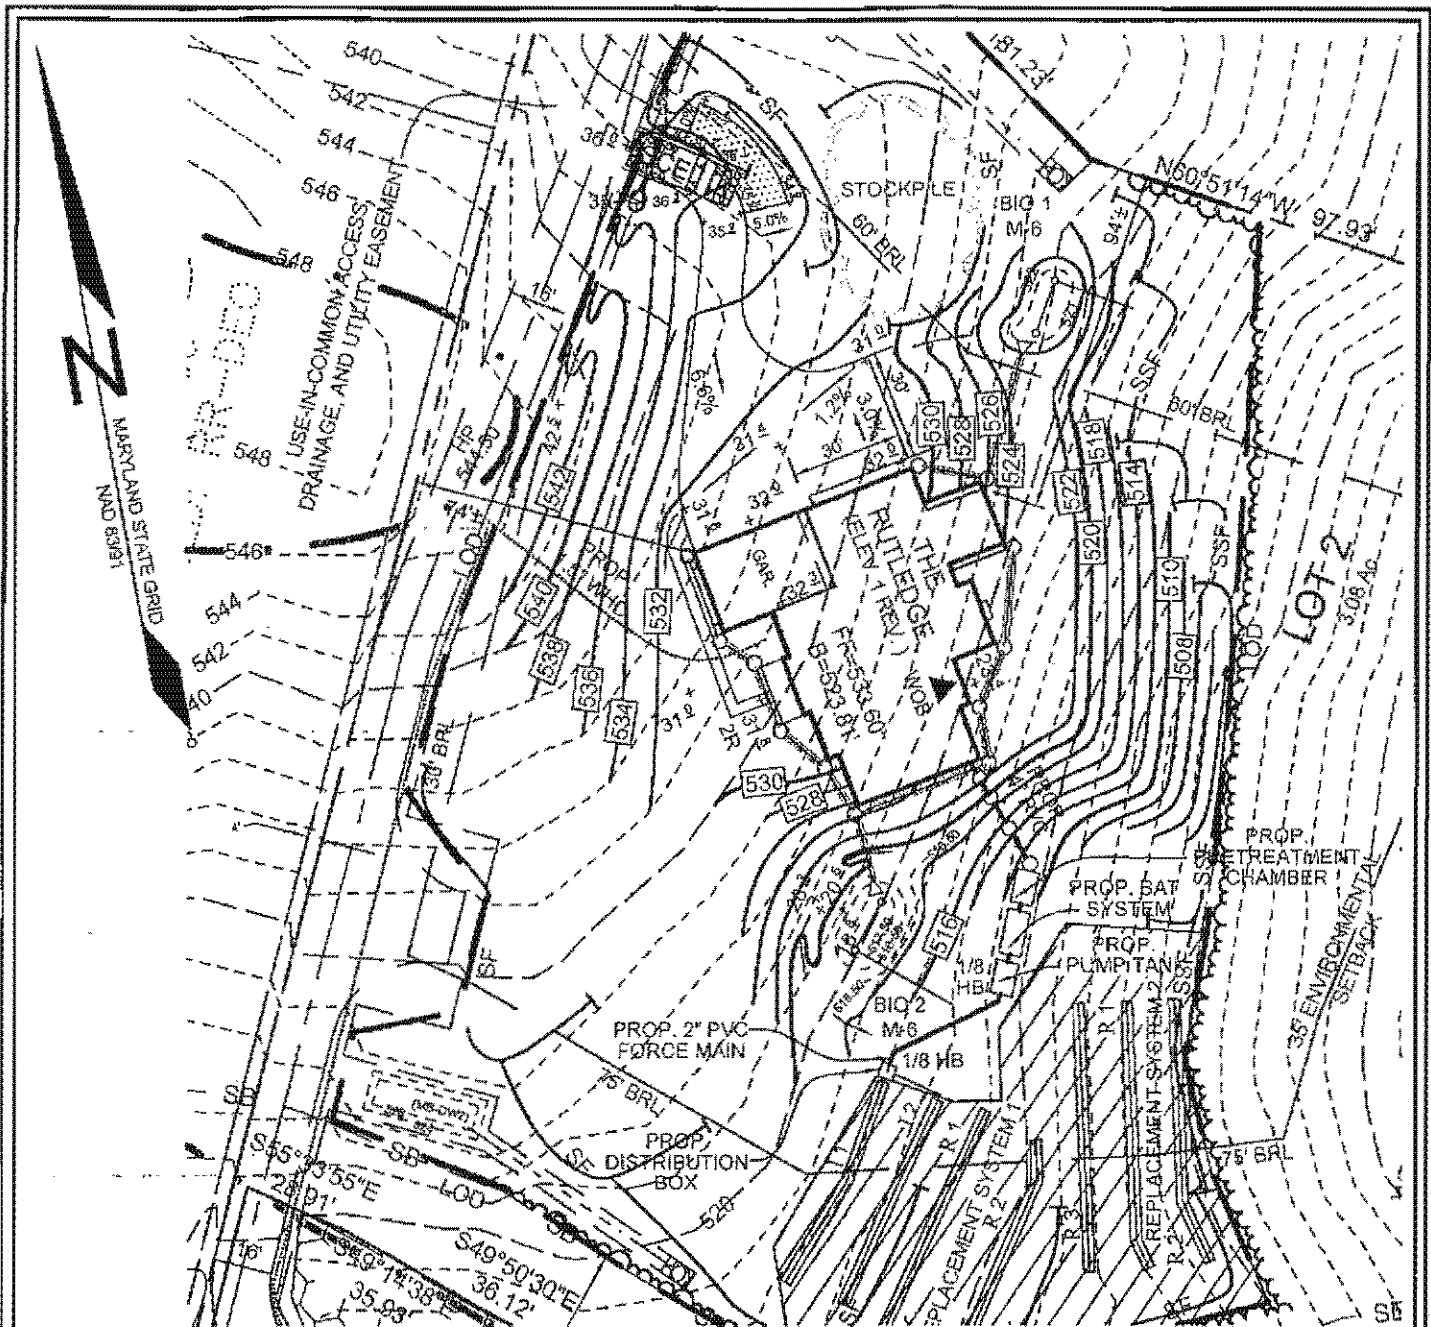

11130 Dovedale Court, Suite 200
 Marriottsville, Maryland 21104
 Phone: 443.325.5076
 Fax: 410.696.2022
 Email: info@sillengineering.com
 Civil Engineering for Land Development



**SILL
 ENGINEERING
 GROUP, LLC**


DESIGN BY: PS
 DRAWN BY: AEA
 CHECKED BY: PS
 SCALE: 1"=50'
 DATE: DECEMBER 4, 2015
 PROJECT #: 15-023
 SHEET #: 1 OF 1

HOUSE RESITE MELCHIOR PROPERTY


LOT 2

TAX MAP 10 GRID 13
 3RD ELECTION DISTRICT


PARCEL 184
 HOWARD COUNTY, MARYLAND

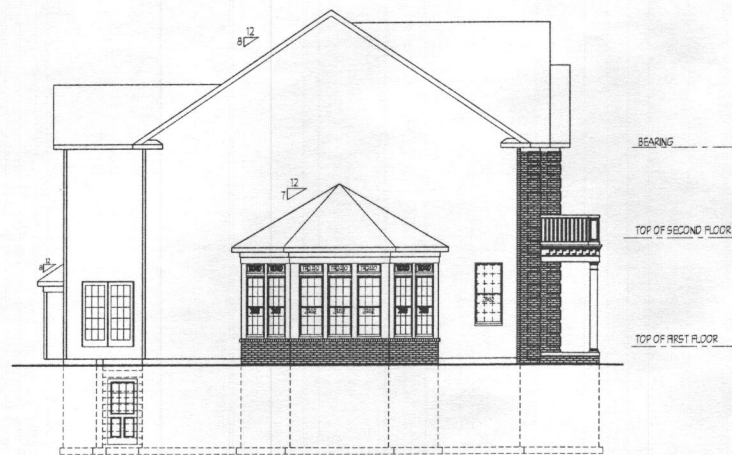

LEFT SIDE ELEVATION 1/8" = 1'-0"
OPTIONAL CONSERVATORY

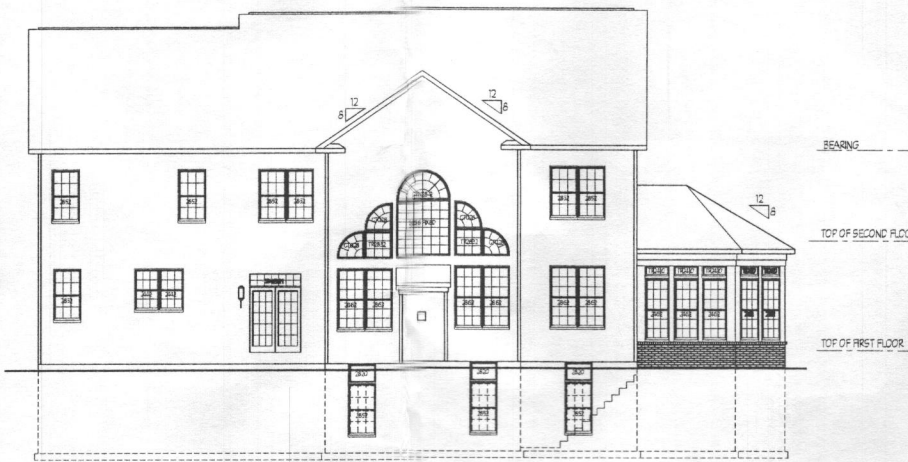


REAR ELEVATION 1/8" = 1'-0"
OPTIONAL WALL OF WINDOWS AND CONSERVATORY

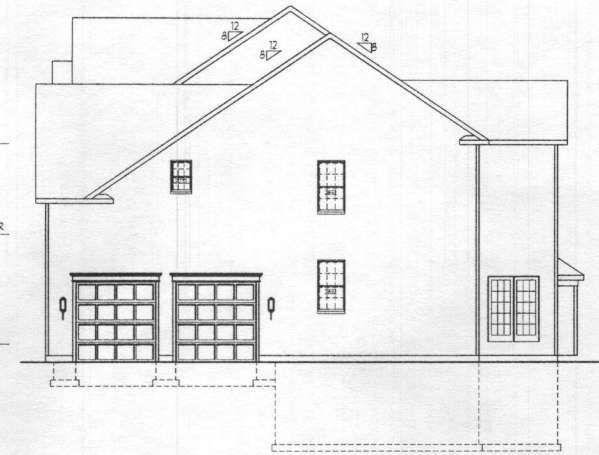


RIGHT SIDE ELEVATION 1/8" = 1'-0"



FRONT ELEVATION 1/4" = 1'-0"
SHOWN WITH OPTIONAL PORTICO PORCH, BRICK VENEER AND CONSERVATORY

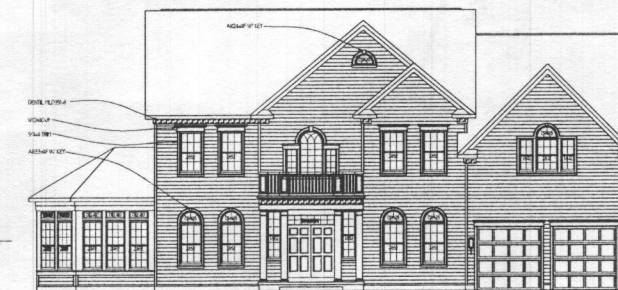

FRONT ELEVATION SIDING

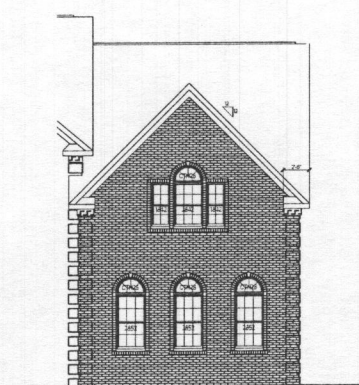

SIDE LOAD CONDITION - 1/8" = 1'-0"

Plymouth Road Architects
640 Plymouth Road, Catonsville, MD 21229 410-788-0281

| DATE | REVISION |
|------|----------|
| | |
| | |
| | |
| | |


Date: 6/15
Scale: NOTED
Drawn: TIM

Drawing: ELEVATION 4
Project: WILLIAMSBURG GROUP
DORCHESTER
ESTATE HOME

1067 D4E
Project No.



REVISED SET 6/15

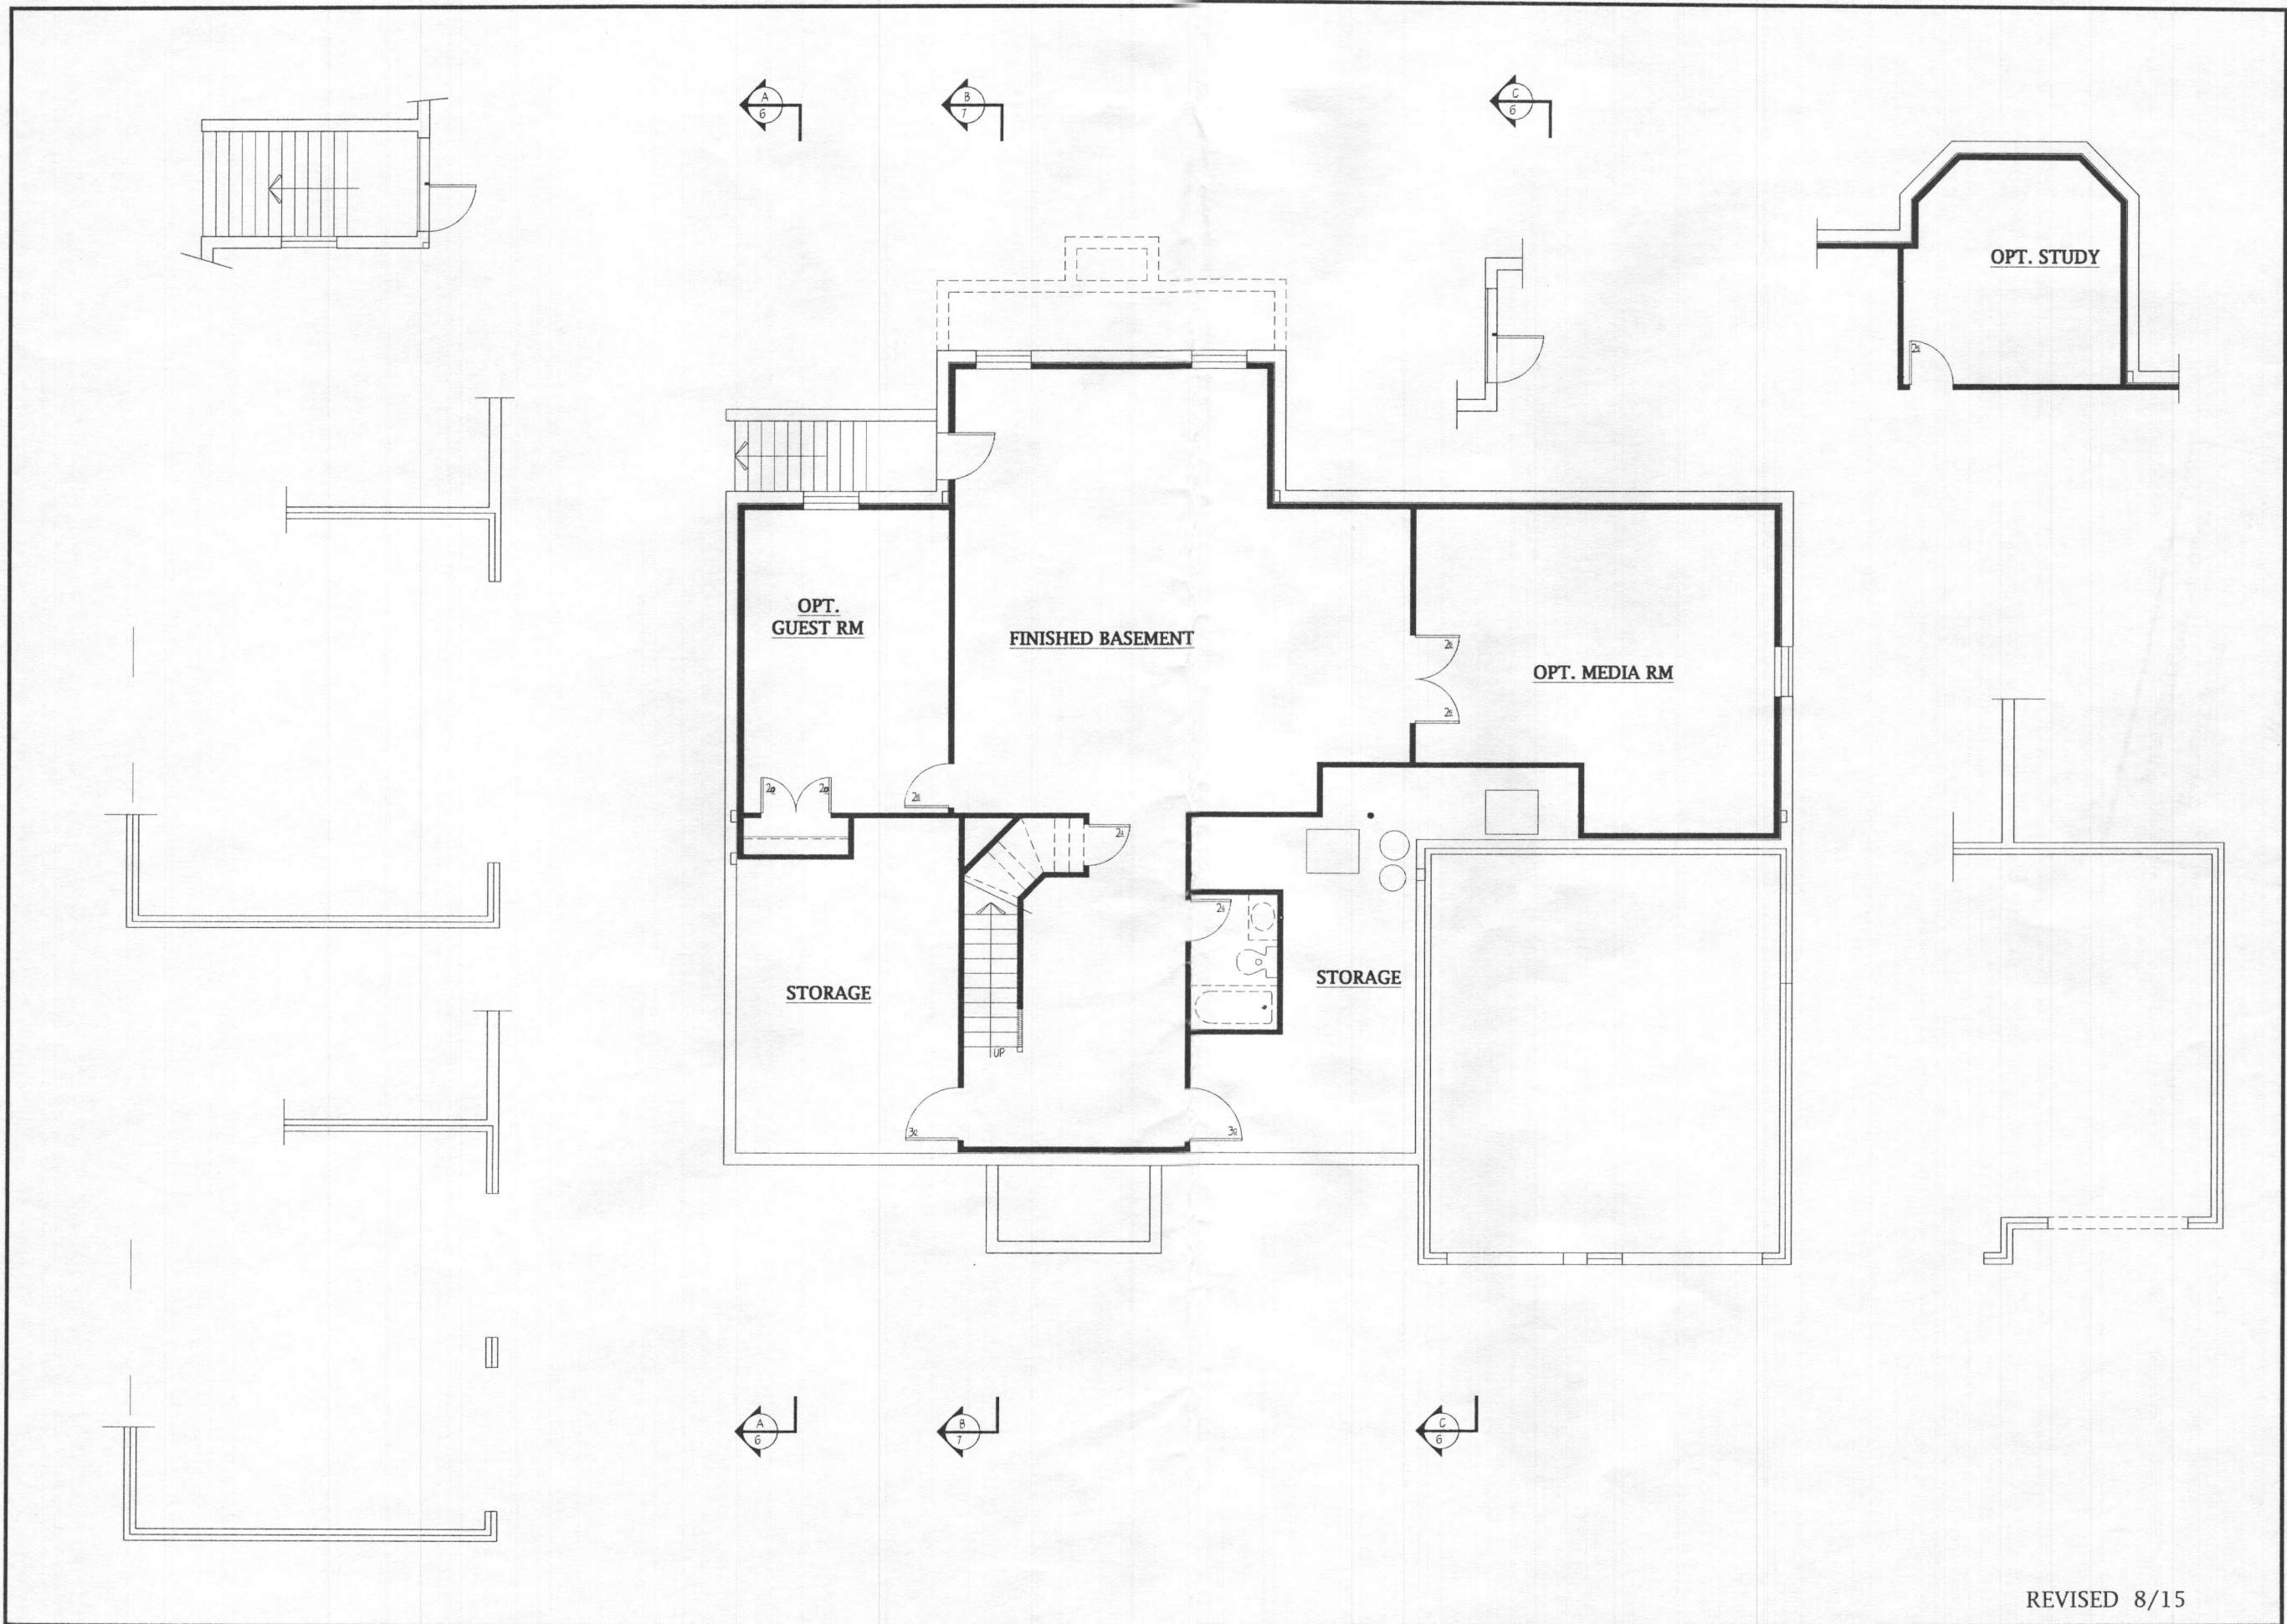

Plymouth Road Architects
 640 Plymouth Road, Catonsville, MD 21229 410-788-0281

| DATE | REVISION |
|------|----------|
| | |
| | |
| | |
| | |

Date: 6/15
 Scale: 1/4" = 1'-0"
 Drawn: TIM

Drawing: FINISHED BSMT PLAN
 Project: WILLIAMSBURG GROUP
 DORCHESTER 4
 ESTATE HOME

1067.D4E
 Project No.

2b

REVISED 8/15





| DATE | REVISION | DATE | REVISION |
|------|---------------|------|----------|
| 8/15 | changed to 1R | | |

Date: 6/15
 Scale: 1/4"=1'-0"
 Drawn: TIM

Drawing: FIRST FLOOR PLAN
 Project: WILLIAMSBURG GROUP
 DORCHESTER
 ESTATE HOME

1067.D4E
 Project No.

3

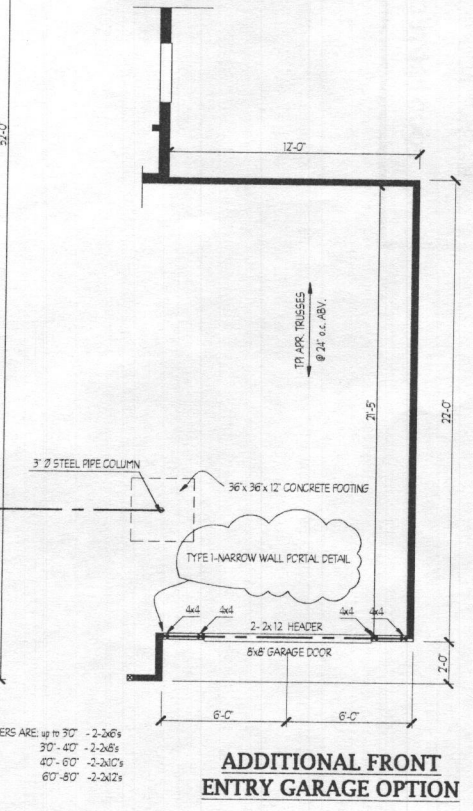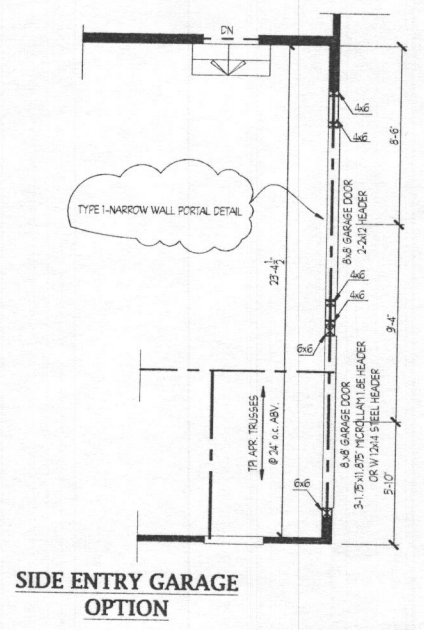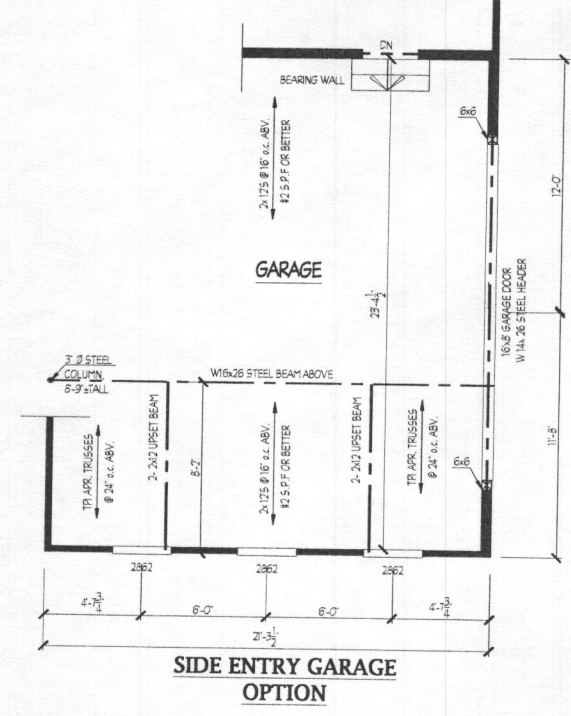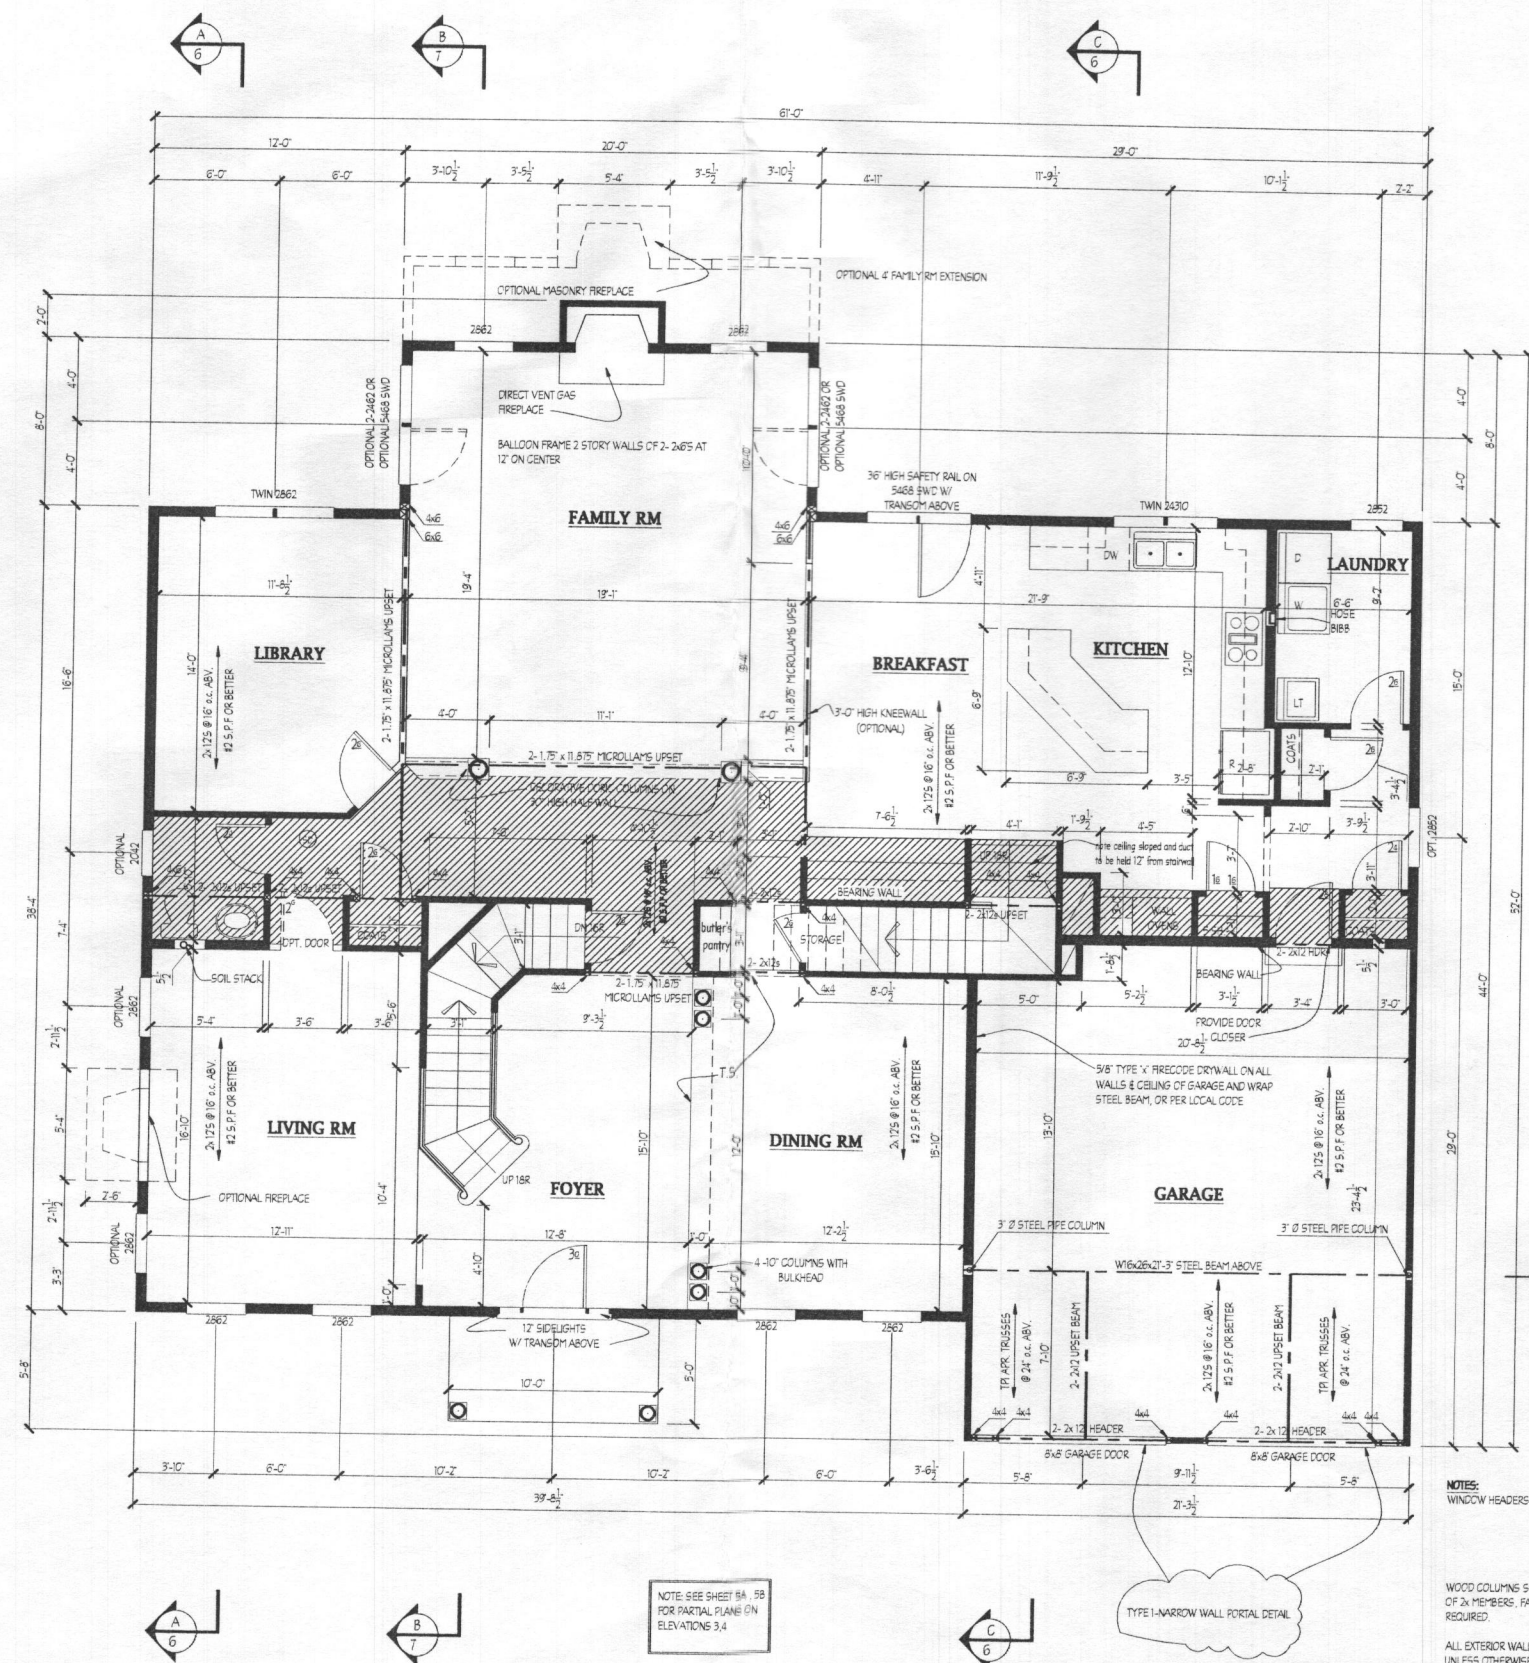

NOTES:
 WINDOW HEADERS ARE: up to 30" - 2-2x6's
 30" - 40" - 2-2x6's
 40" - 60" - 2-2x10's
 60" - 80" - 2-2x12's


WOOD COLUMN(S) SPECIFIED MAY BE BUILT UP OF 2x MEMBERS, FASTENED TOGETHER AS REQUIRED.

ALL EXTERIOR WALLS TO BE 2x @ 16" OC UNLESS OTHERWISE NOTED.



NOTE: SUBSTITUTION OF ENGINEERED I-JOISTS DESIGNED BY OTHERS IN LIEU OF DIMENSIONAL 2x LUMBER SPECIFIED FOR FLOOR FRAMING IS ACCEPTABLE.

NOTE: SEE SHEET BA-5B FOR PARTIAL PLANS ON ELEVATIONS 3,4

REVISED 8/15

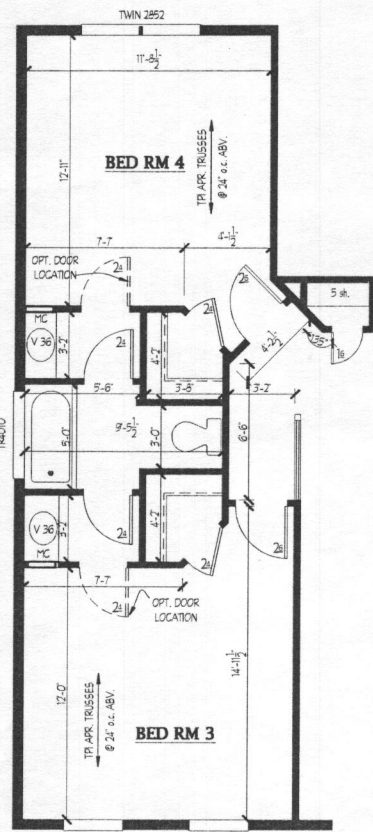

OPTIONAL BUDDY BATH

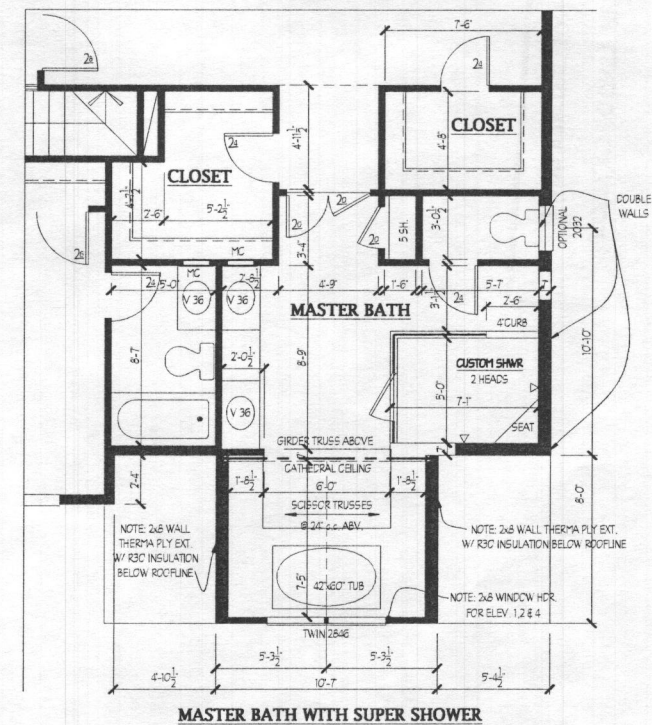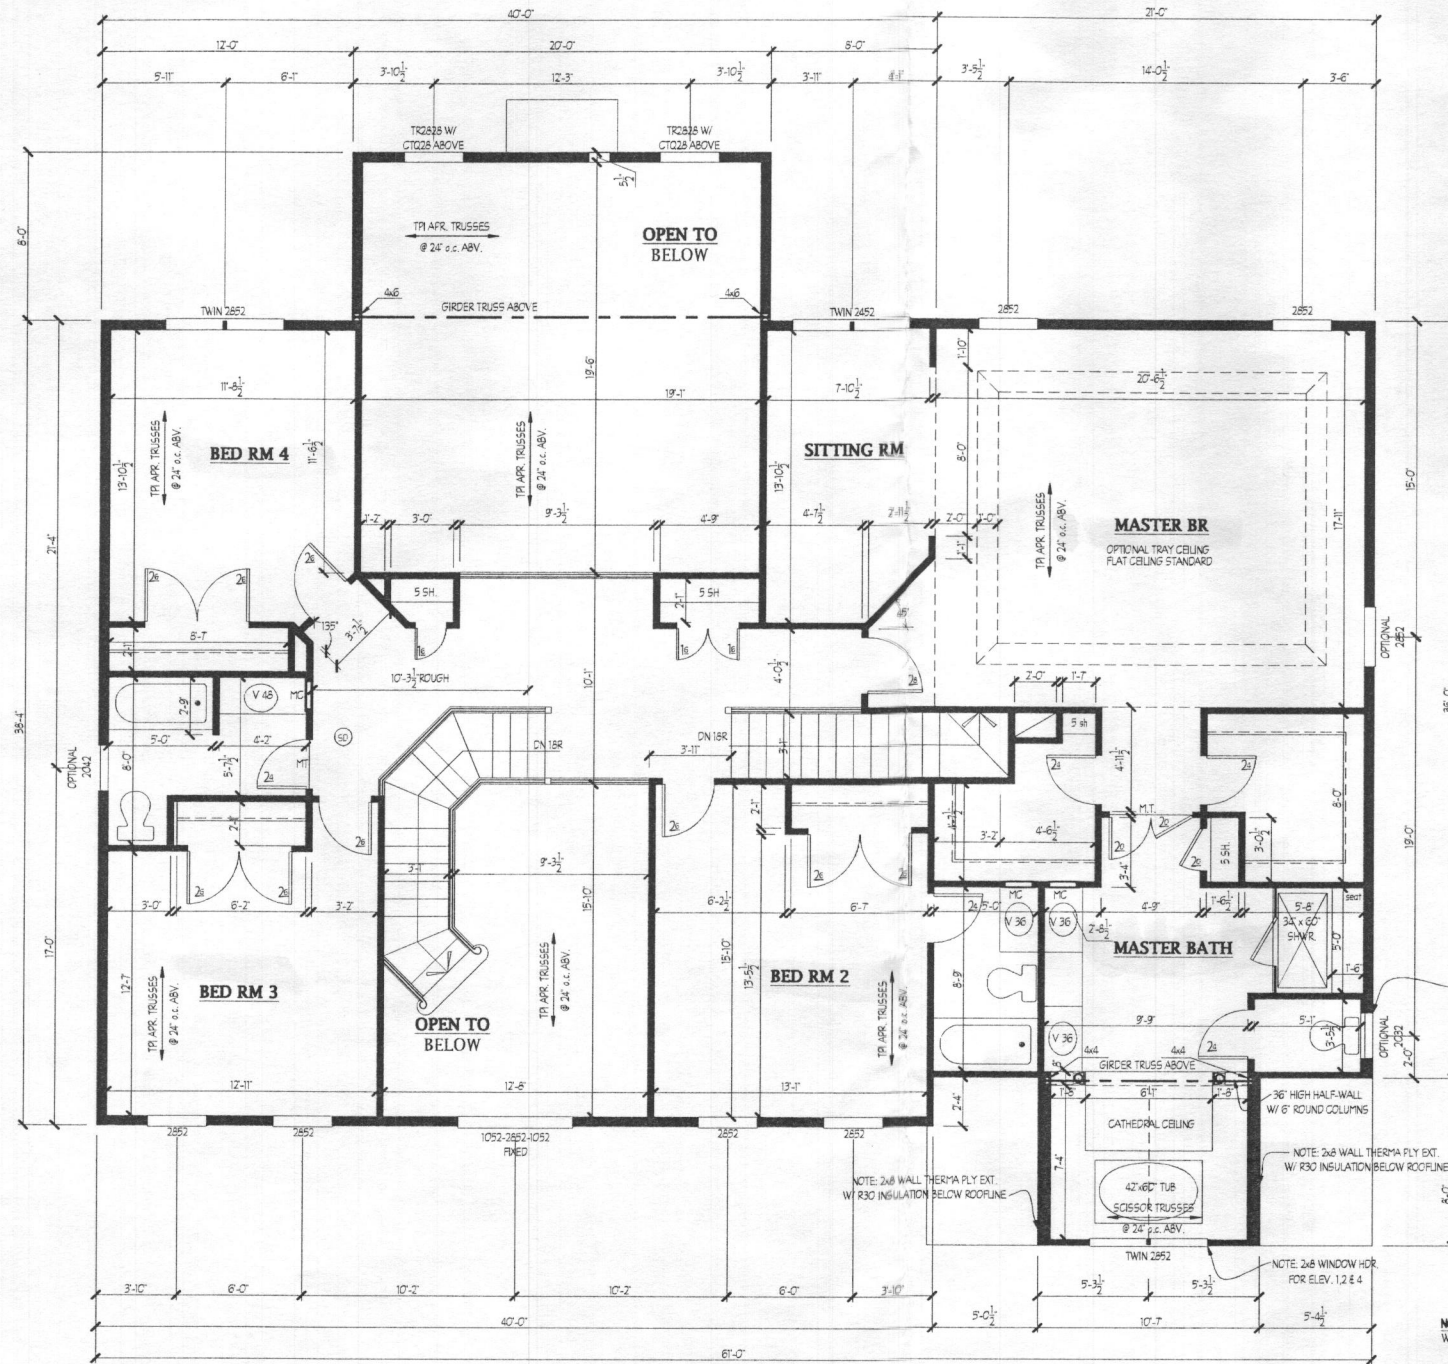

MASTER BATH WITH SUPER SHOWER

- NOTES:**
- WINDOW HEADERS ARE: up to 30" - 2-2x6's
 - 30" - 40" - 2-2x6's
 - 40" - 60" - 2-3x7's
 - 60" - 80" - 2-3x9's
- ROUGH HD HEIGHTS ARE AT 7'-6" UNLESS NOTED OTHERWISE
- ALL HEADERS IN BEARING WALLS ARE 2-2x7's UNLESS NOTED OTHERWISE
- WOOD COLUMNS SPECIFIED MAY BE BUILT UP OF 2x MEMBERS, FASTENED TOGETHER AS REQUIRED
- ALL EXTERIOR WALLS TO BE 2x6 @ 16"oc UNLESS OTHERWISE NOTED
- NOTE: SUBSTITUTION OF ENGINEERED I-JOISTS DESIGNED BY OTHERS IN LIEU OF DIMENSIONAL 2x LUMBER SPECIFIED FOR FLOOR FRAMING IS ACCEPTABLE.

NOTE: SEE SHEET SA_58 FOR PARTIAL PLANS ON ELEVATIONS 3,4

Plymouth Road Architects
640 Plymouth Road, Catonsville, MD 21229 410-788-0281

| DATE: | REVISION: |
|-------|----------------|
| 8/15 | changed to 18r |

Date: 6/15
Scale: 1/4" = 1'-0"
Drawn: TIM

Drawing: SECOND FLOOR PLAN +2'
Project: WILLIAMSBURG GROUP
DORCHESTER 4
ESTATE HOME

1067.D4E
Project No.

4

REVISED 8/15

| SOILS LEGEND | | | |
|--------------|---------------------------------------|-------|------------|
| SYMBOL | NAME / DESCRIPTION | GROUP | 'K' FACTOR |
| GgB | GLADSTONE LOAM, 3 TO 8 PERCENT SLOPES | B | 0.20 |
| MgD | MANOR LOAM, 15 TO 25 PERCENT SLOPES | B | 0.24 |

- NOTES:
- SOIL INFORMATION HAS BEEN TAKEN FROM THE UNITED STATES DEPARTMENT OF AGRICULTURE, NATURAL RESOURCES CONSERVATION SERVICE, WEB SOIL SURVEY.
 - HIGHLY ERODIBLE SOILS ARE THOSE SOILS WITH A SLOPE GREATER THAN 15 PERCENT OR THOSE SOILS WITH A SOIL ERODIBILITY FACTOR 'K' GREATER THAN 0.35 AND WITH A SLOPE GREATER THAN 5 PERCENT.

| BENCHMARKS | | | | |
|------------|-----------|-------------|-----------|---|
| NUMBER | NORTHING | EASTING | ELEVATION | DESCRIPTION |
| 09H2 | 601,676.7 | 1,329,521.0 | 640.22 | N SIDE OF RT. 99, 0.6 MILE TO RT. 32, 500' TO CL OF MT. VIEW, 48' N OF POLE #102450 |
| 10GB | 602,276.0 | 1,331,069.4 | 597.35 | S SIDE OF RT. 99, 59' E OF POLE #G-27, 100' W OF F.H. |


STANDARD STABILIZATION NOTE

FOLLOWING INITIAL SOIL DISTURBANCE OR REDISTURBANCE, PERMANENT OR TEMPORARY STABILIZATION MUST BE COMPLETED WITHIN:

- THREE (3) CALENDAR DAYS AS TO THE SURFACE OF ALL PERIMETER DIKES, SWALES, DITCHES, PERIMETER SLOPES AND ALL SLOPES STEEPER THAN 3 HORIZONTAL TO 1 VERTICAL (3:1); AND
- SEVEN (7) CALENDAR DAYS AS TO ALL OTHER DISTURBED OR GRADED AREAS ON THE PROJECT SITE NOT UNDER ACTIVE GRADING.

DURING GRADING AND AFTER EACH RAINFALL, CONTRACTOR WILL INSPECT AND PROVIDE NECESSARY MAINTENANCE TO THE SEDIMENT CONTROL MEASURES ON THIS PLAN.


- LEGEND**
- EXISTING CONTOUR
 - PROPOSED CONTOUR
 - PROPOSED SPOT ELEVATION
 - DIRECTION OF FLOW
 - EXISTING TREELINE
 - PROPOSED TREELINE
 - EXISTING TREE
 - SOIL BOUNDARY
 - EXISTING FOREST CONSERVATION EASEMENT PER F-13-075
 - STABILIZED CONSTRUCTION ENTRANCE
 - SILT FENCE
 - SUPER SILT FENCE
 - LIMIT OF DISTURBANCE
 - PROPOSED ROOF LEADER (4" PVC TYP. WITH DOWNSPOUT)
 - PROPOSED BIORETENTION FACILITY
 - EX. SEPTIC EASEMENT
 - PROPOSED 1.5' WHC

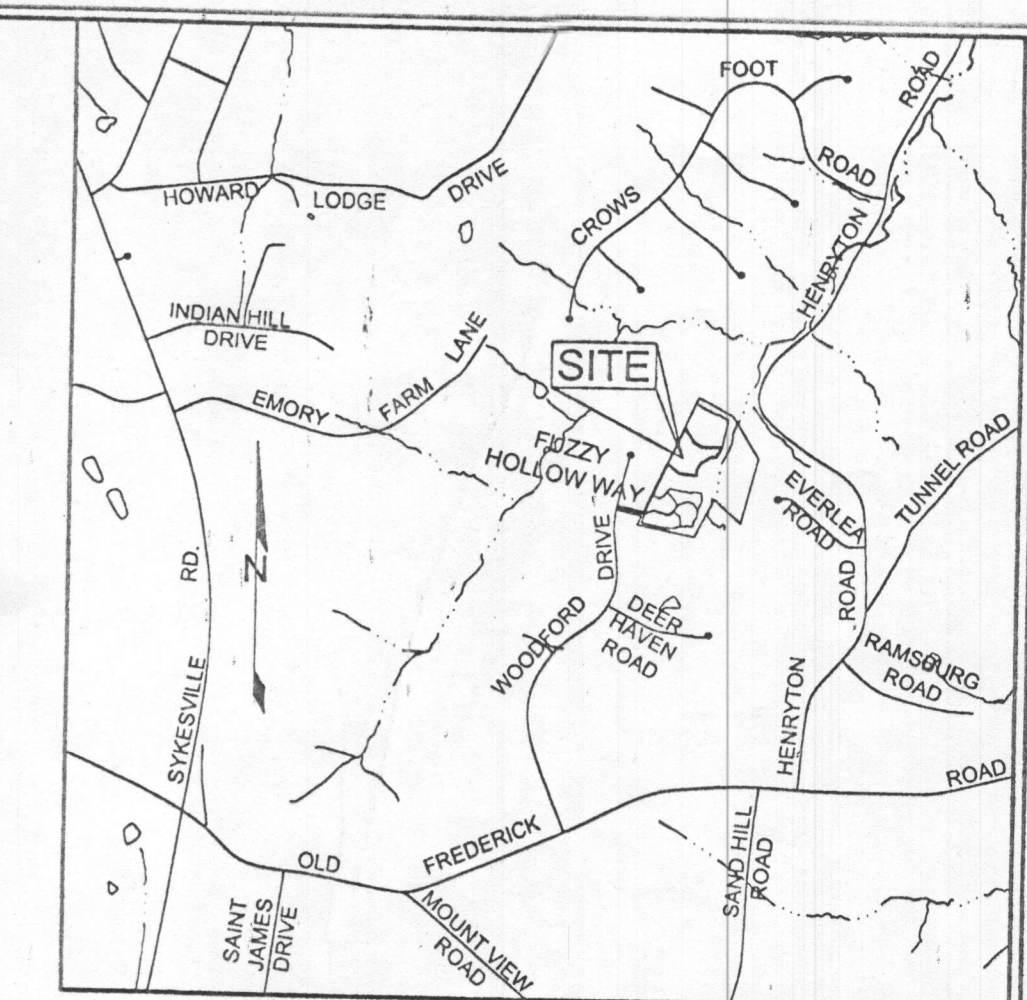

VICINITY MAP
SCALE: 1"=2000'



PLAN VIEW
SCALE: 1"=50'

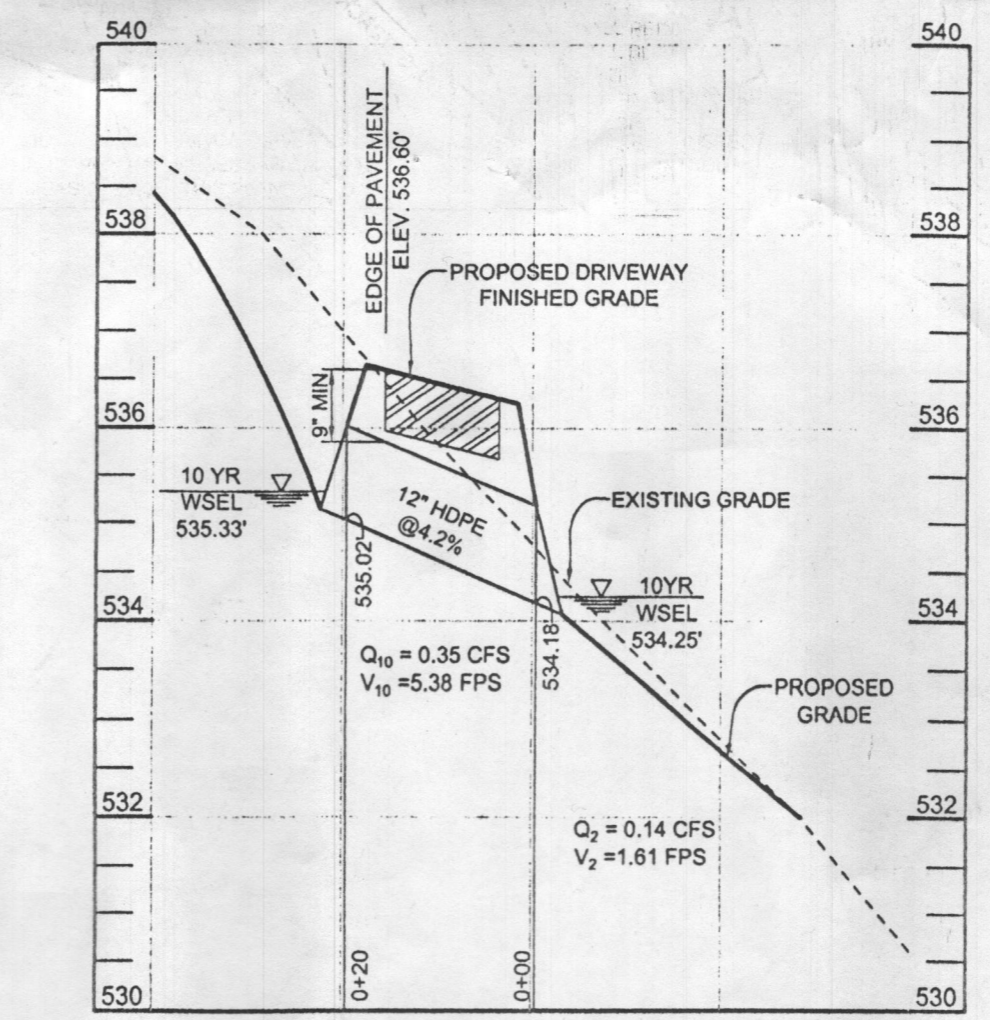

CULVERT PROFILE
HORIZONTAL SCALE: 1"=20'
VERTICAL SCALE: 1"=2'

- GENERAL NOTES**
- SUBJECT PROPERTY ZONED RR-DEO PER 10/08/13 COMPREHENSIVE ZONING PLAN.
 - TOTAL AREA OF LOT = 3.08 AC.±
 - PUBLIC WATER AND PRIVATE SEWER WILL BE USED WITHIN THIS SITE.
 - ZZZZ THIS AREA DESIGNATES A PRIVATE SEWAGE EASEMENT, OF AT LEAST 10,000 SF AS REQUIRED BY THE MARYLAND STATE DEPARTMENT OF THE ENVIRONMENT FOR INDIVIDUAL SEWAGE DISPOSAL (COMAR 26.03.03). IMPROVEMENTS OF ANY NATURE IN THIS AREA ARE RESTRICTED UNTIL PUBLIC SEWERAGE IS AVAILABLE. THESE EASEMENTS SHALL BECOME NULL AND VOID UPON CONNECTION TO A PUBLIC SEWERAGE SYSTEM. THE COUNTY HEALTH OFFICER SHALL HAVE THE AUTHORITY TO GRANT ADJUSTMENTS TO THE PRIVATE SEWAGE EASEMENT. RECORDATION OF A MODIFIED SEWAGE EASEMENT SHALL NOT BE NECESSARY.
 - WATER WILL BE PUBLIC (CONTRACT # 44-4791-D). WATER SERVICE TO THIS LOT WILL BE GRANTED UNDER PROVISIONS OF SECTION 18.122.B OF THE HOWARD COUNTY CODE VIA CONNECTIONS TO EXISTING CONTRACT # W-44-3478.
 - ALL EXISTING WELLS, SEPTIC SYSTEMS AND SEWAGE DISPOSAL EASEMENTS WITHIN 100 FEET OF THE PROPERTY BOUNDARIES AND ALL EXISTING AND PROPOSED WELLS THAT ARE LOCATED WITHIN 200 FEET DOWN-GRADE OF EXISTING OR PROPOSED SEPTIC SYSTEMS AND SEWAGE DISPOSAL EASEMENTS HAVE BEEN FIELD LOCATED.
 - THE BOUNDARY SHOWN HEREON IS BASED ON A FIELD RUN BOUNDARY SURVEY PREPARED BY MILDENBERG, BOENDER AND ASSOC. IN OCTOBER 2012.
 - THE TOPOGRAPHY SHOWN HEREON HAS BEEN FIELD RUN BY CHRISTOPHER CONSULTANTS, INC. IN NOVEMBER 2004. THE EXISTING TOPOGRAPHY SHOWN OUTSIDE THE SITE IS BASED ON HOWARD COUNTY TERRAINAL TOPOGRAPHY FLOWN IN 2004.
 - THE SOILS SHOWN HAVE BEEN TAKEN FROM THE NRCS WEB SOIL SURVEY W-13 SITE, HOWARD COUNTY SOILS GRID 4, SOILS MAP G-100 193.
 - THE COORDINATES SHOWN HEREON ARE BASED UPON THE HOWARD COUNTY GEODETIC CONTROL WHICH IS BASED ON THE MARYLAND STATE PLANE COORDINATE SYSTEM. HOWARD COUNTY MONUMENTS, NUMBERS 09H2 AND 10GB, WERE USED FOR THIS PROJECT.
 - THERE ARE NO HISTORIC STRUCTURES OR CEMETERIES WITHIN THE PROJECT BOUNDARY.
 - THE CONTRACTOR SHALL NOTIFY MISS UTILITY AT 1-800-257-7777 AT LEAST 48 HOURS PRIOR TO ANY EXCAVATION WORK BEING DONE.
 - ANY DAMAGE TO PUBLIC RIGHT-OF-WAYS, PAVING OR EXISTING UTILITIES WILL BE CORRECTED AT THE CONTRACTOR'S EXPENSE.
 - THE LOTS SHOWN HEREON COMPLY WITH THE MINIMUM OWNERSHIP, WIDTH AND LOT AREA AS REQUIRED BY THE MARYLAND STATE DEPARTMENT OF THE ENVIRONMENT.
 - ALL DITCHES AND SWALES WILL HAVE SOIL STABILIZATION MATTING UNLESS SOD IS BEING UTILIZED.
 - NO GRADING, REMOVAL OF VEGETATIVE COVER OR TREES, PAVING AND NEW STRUCTURES SHALL BE PERMITTED WITHIN THE LIMITS OF WETLANDS, STREAMS, OR THEIR REQUIRED BUFFERS, FLOODPLAIN AND FOREST CONSERVATION EASEMENT AREAS, UNLESS WAIVERS HAVE BEEN APPROVED.
 - STORMWATER MANAGEMENT OBLIGATIONS FOR THIS LOT HAVE BEEN MET BY NON-ROOFTOP DISCONNECTS AND MICRO BIORETENTION FACILITIES. STORMWATER MANAGEMENT OBLIGATIONS FOR MELCHIOR PROPERTY HAVE BEEN APPROVED UNDER F. SEE THE FINAL STORMWATER MANAGEMENT REPORT FOR ADDITIONAL INFORMATION.
 - REFUSE COLLECTION, SNOW REMOVAL, AND ROAD MAINTENANCE FOR PIPESTEM LOTS ARE PROVIDED TO THE JUNCTION OF THE PUBLIC ROAD AND THE PIPESTEM DRIVEWAY. COUNTY TRASH AND RECYCLING COLLECTION WILL BE AT WOODFORD DRIVE WITHIN 5' OF THE COUNTY ROADWAY.
 - DRIVEWAY(S) SHALL BE PROVIDED PRIOR TO ISSUANCE OF A USE AND OCCUPANCY PERMIT FOR ANY NEW DWELLINGS TO ENSURE SAFE ACCESS FOR FIRE AND EMERGENCY VEHICLES PER THE FOLLOWING REQUIREMENTS:
 - WIDTH - 12 FEET (16 FEET SERVING MORE THAN ONE RESIDENCE);
 - SURFACE - SIX (6) INCHES OF COMPACTED CRUSHER RUN BASE WITH TAR AND CHIP COATING (1-1/2" MINIMUM);
 - GOMETRY - MAXIMUM 15% GRADE, MAXIMUM 10% GRADE CHANGE AND 45-FOOT TURNING RADIUS;
 - STRUCTURES (CULVERTS/BRIDGES) - CAPABLE OF SUPPORTING 25 GROSS TONS (H25-LOADING);
 - DRAINAGE ELEMENTS - CAPABLE OF SAFELY PASSING 100 YEAR FLOOD WITH NO MORE THAN 1 FOOT DEPTH OVER DRIVEWAY SURFACE;
 - MAINTENANCE - SUFFICIENT TO ENSURE ALL WEATHER USE.
 - PROVIDE SOD FOR 10' UPSTREAM AND DOWNSTREAM OF ALL CULVERTS, AND FOR ONE VERTICAL FOOT ALONG SWALE SIDES.
 - LIMIT OF DISTURBANCE = 69,309 ± SQ. FT OR 1.5911 AC.±.

OWNER/DEVELOPER
WILLIAMSBURG GROUP
5465 HARRERS FARM ROAD
COLUMBIA, MARYLAND 21044

Approved Septic System Plan
Howard County Health Department
Dana Beard 11-24-15
Signature Date
B15005307

GRADING PLAN
MELCHIOR PROPERTY
LOT 2

TAX MAP 10 GRID 13
3RD ELECTION DISTRICT

PARCEL 184
HOWARD COUNTY, MARYLAND

DESIGN BY: PS
DRAWN BY: AEA
CHECKED BY: PS
SCALE: AS SHOWN
DATE: NOVEMBER 23, 2015
PROJECT #: 15-023
SHEET #: 1 OF 2

SILL ENGINEERING GROUP, LLC
11130 Doveedale Court, Suite 200
Marriottsville, Maryland 21104
Phone: 443.325.5076
Fax: 410.696.2022
Email: info@sillengineering.com
Civil Engineering for Land Development

PROFESSIONAL CERTIFICATION: I HEREBY CERTIFY THAT THESE DOCUMENTS WERE PREPARED OR APPROVED BY ME, AND THAT I AM A DULY LICENSED PROFESSIONAL ENGINEER UNDER THE LAWS OF THE STATE OF MARYLAND, LICENSE NO. 30225, EXPIRATION DATE: JUNE 20, 2017

THIS DEVELOPMENT PLAN IS APPROVED FOR SOIL EROSION AND SEDIMENT CONTROL BY THE HOWARD SOIL CONSERVATION DISTRICT

ENGINEER'S CERTIFICATE
I CERTIFY THAT THIS PLAN FOR SEDIMENT AND EROSION CONTROL REPRESENTS A PRACTICAL AND WORKABLE PLAN BASED ON MY PERSONAL KNOWLEDGE OF THE SITE CONDITIONS AND THAT IT WAS PREPARED IN ACCORDANCE WITH THE REQUIREMENTS OF THE HOWARD SOIL CONSERVATION DISTRICT.
Paul M. Sill, P.E. 11/23/15
SIGNATURE OF ENGINEER DATE

DEVELOPER'S CERTIFICATE
I/WE CERTIFY THAT ALL DEVELOPMENT AND CONSTRUCTION WILL BE DONE ACCORDING TO THIS PLAN FOR SEDIMENT AND EROSION CONTROL, AND THAT ALL RESPONSIBLE PERSONNEL INVOLVED IN THE CONSTRUCTION PROJECT WILL HAVE A CERTIFICATE OF ATTENDANCE AT A DEPARTMENT OF THE ENVIRONMENT APPROVED TRAINING PROGRAM FOR THE CONTROL OF SEDIMENT AND EROSION BEFORE BEGINNING THE PROJECT. I ALSO AUTHORIZE PERSONS TO BE INSPECTED BY THE HOWARD SOIL CONSERVATION DISTRICT.
Dana Beard 11-24-15
SIGNATURE OF DEVELOPER DATE

